

Dist	COUNTY	LOCATION CODE	POST MILES TOTAL PROJECT	SHEET No.	TOTAL SHEETS
08	SBd	5712		1	22


STATE OF CALIFORNIA
DEPARTMENT OF TRANSPORTATION
PROJECT PLANS FOR BUILDING CONSTRUCTION
IN SAN BERNARDINO COUNTY
IN BLOOMINGTON
AT MAGANA-ORTEGA MAINTENANCE STATION
AT 451 WEST SLOVER AVENUE

INDEX OF PLANS

SHEET No.	DESCRIPTION
1	TITLE AND LOCATION MAP
2-5	REVISED AND NEW STANDARD PLANS
BUILDING PLANS	
6	EXISTING GENERAL PLAN
7-13	MECHANICAL PLANS
14-22	ELECTRICAL PLANS

THE STANDARD PLANS LIST APPLICABLE TO THIS CONTRACT IS INCLUDED IN THE NOTICE TO BIDDERS AND SPECIAL PROVISIONS BOOK.

TO BE SUPPLEMENTED BY STANDARD PLANS DATED MAY 2006

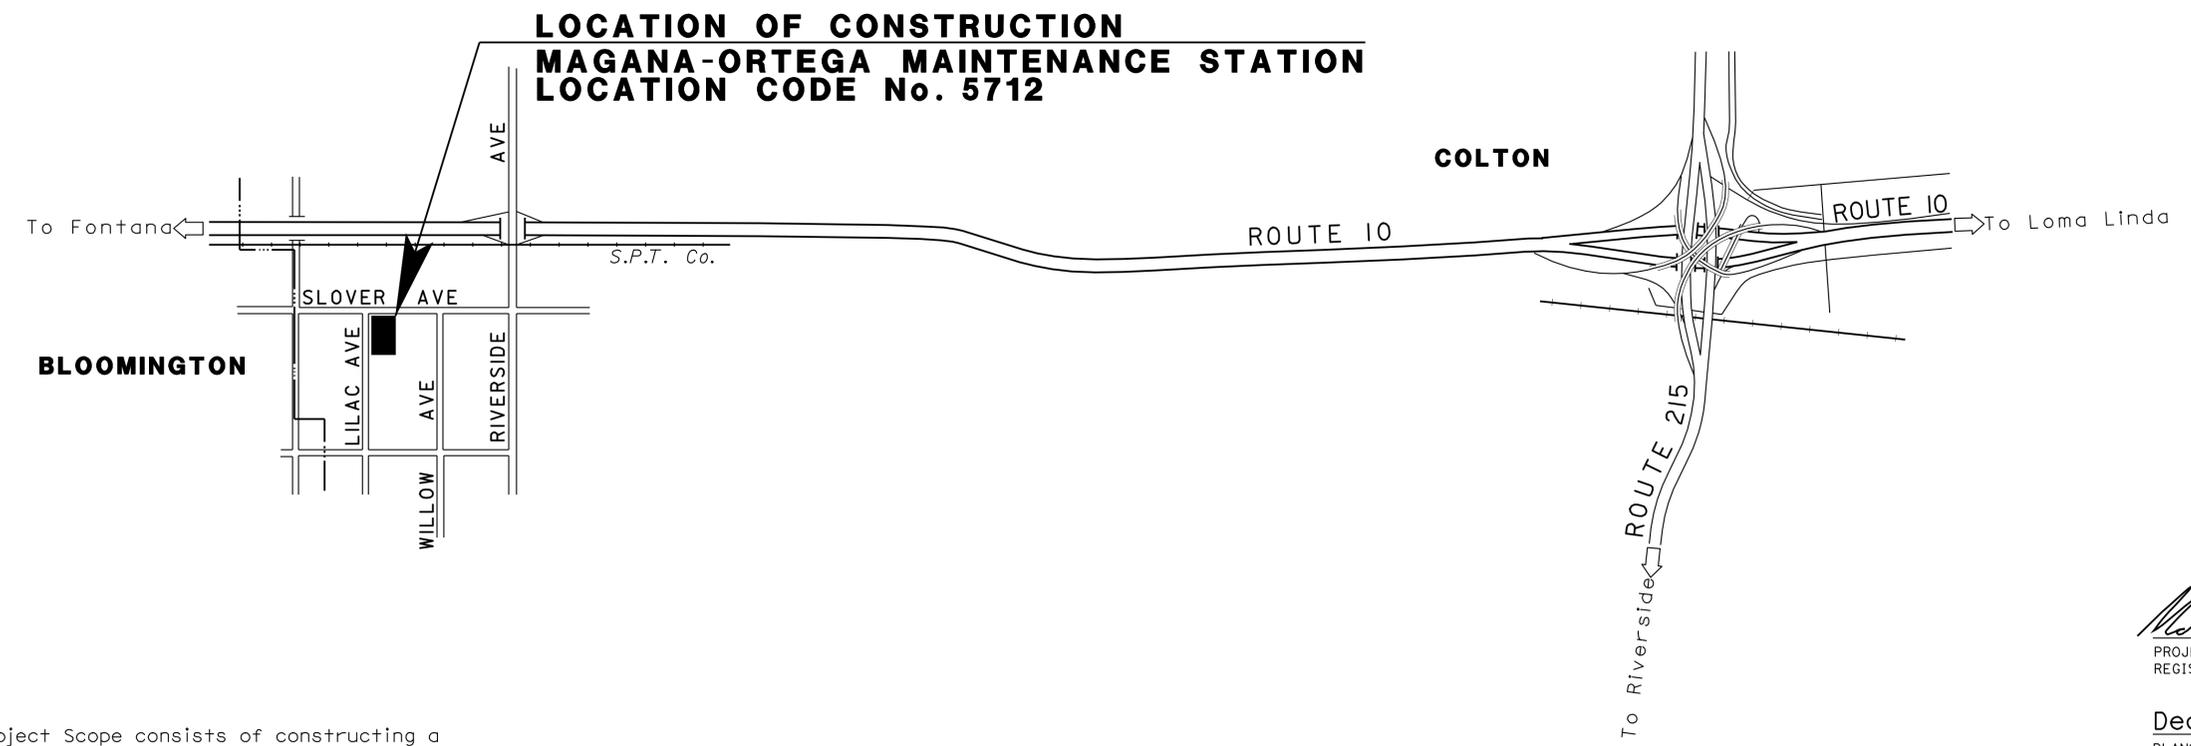

LOCATION OF CONSTRUCTION
MAGANA-ORTEGA MAINTENANCE STATION
LOCATION CODE No. 5712

NO SCALE

Project Scope: Project Scope consists of constructing a compressed natural gas (CNG) fuel station capable of both time fill, and quick fill fueling of CNG powered vehicles.

Mark Hedglin 03-15-12
 PROJECT ENGINEER DATE
 REGISTERED MECHANICAL ENGINEER



December 24, 2012
 PLANS APPROVAL DATE

THE STATE OF CALIFORNIA OR ITS OFFICERS OR AGENTS SHALL NOT BE RESPONSIBLE FOR THE ACCURACY OR COMPLETENESS OF SCANNED COPIES OF THIS PLAN SHEET.

PROJECT MANAGER	MUSTAPHA IAALI
DESIGN ENGINEER	MARK HEDGLIN

THE CONTRACTOR SHALL POSSESS THE CLASS (OR CLASSES) OF LICENSE AS SPECIFIED IN THE "NOTICE TO BIDDERS."

CONTRACT No.	08-0M0204
PROJECT ID	080000454

16-JAN-2013 05:35 TIME PLOTTED => 05:35


DIST	COUNTY	ROUTE	POST MILES TOTAL PROJECT	SHEET NO.	TOTAL SHEETS
08	SBd	5712		2	22

Randell D. Hiatt
REGISTERED CIVIL ENGINEER

June 6, 2008
PLANS APPROVAL DATE


The State of California or its officers or agents shall not be responsible for the accuracy or completeness of electronic copies of this plan sheet.

To accompany plans dated 12-24-12

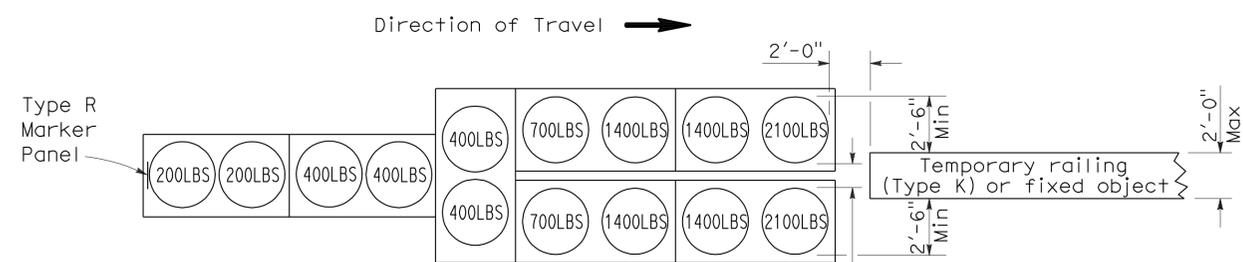


ARRAY 'TU14'

Approach speed 45 mph or more

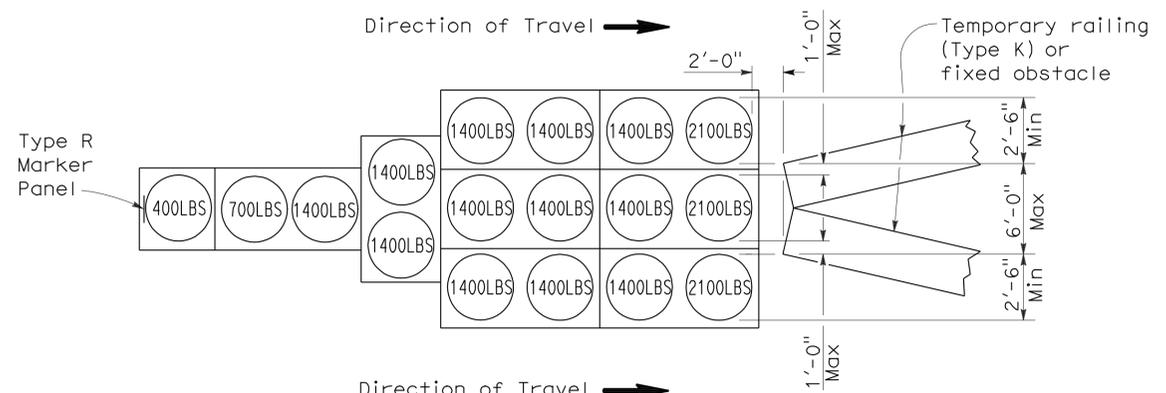


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Approach speed less than 45 mph

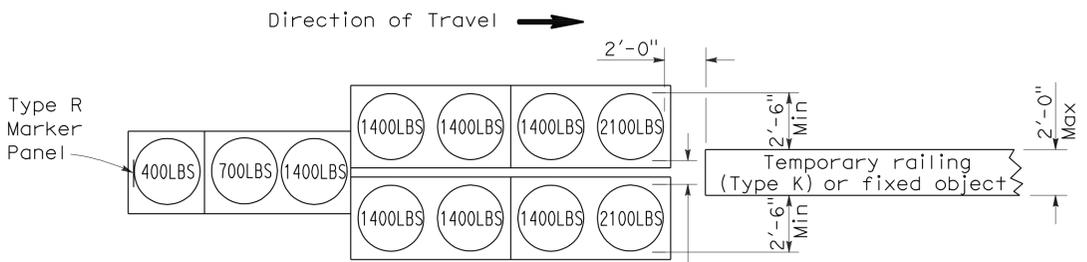


ARRAY 'TU11'

Approach speed less than 45 mph

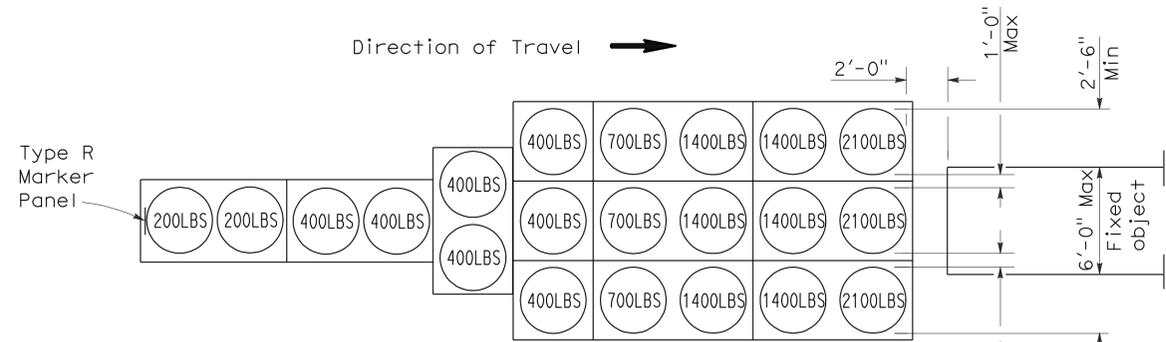


ARRAY 'TU21'

Approach speed 45 mph or more

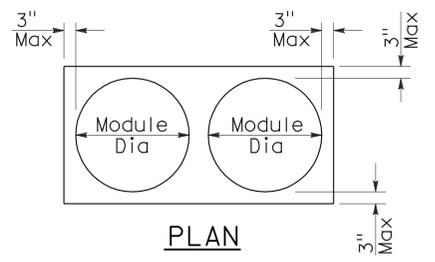

PLAN

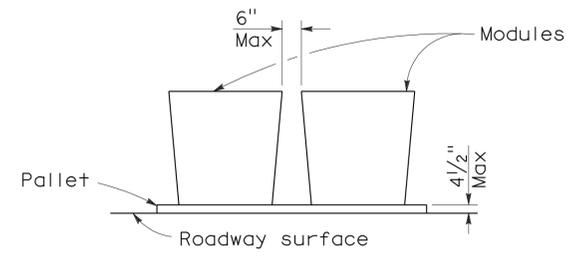

ELEVATION

CRASH CUSHION PALLET DETAIL

See Note 7

NOTES:

1. (XXX) Indicates sand filled module location and weight of sand in pounds for each module. Module spacing is based on the greater diameter of the module.
2. All sand weights are nominal.
3. Temporary crash cushion arrays shall not encroach on the traveled way.
4. Place the top of Type R marker panel 1" below the module lid.
5. Refer to Standard Plan A73B for marker details.
6. Approach speeds indicated conform to NCHRP 350 Report criteria.
7. Use of pallets is optional.

STATE OF CALIFORNIA
DEPARTMENT OF TRANSPORTATION

**TEMPORARY CRASH CUSHION,
SAND FILLED
(UNIDIRECTIONAL)**

NO SCALE

RSP T1A DATED JUNE 6, 2008 SUPERSEDES STANDARD PLAN T1A
DATED MAY 1, 2006 - PAGE 211 OF THE STANDARD PLANS BOOK DATED MAY 2006.

REVISED STANDARD PLAN RSP T1A

2006 REVISED STANDARD PLAN RSP T1A


DIST	COUNTY	ROUTE	POST MILES TOTAL PROJECT	SHEET NO.	TOTAL SHEETS
08	SBd	5712		3	22

Randell D. Hiatt
REGISTERED CIVIL ENGINEER

June 6, 2008
PLANS APPROVAL DATE


The State of California or its officers or agents shall not be responsible for the accuracy or completeness of electronic copies of this plan sheet.

To accompany plans dated 12-24-12

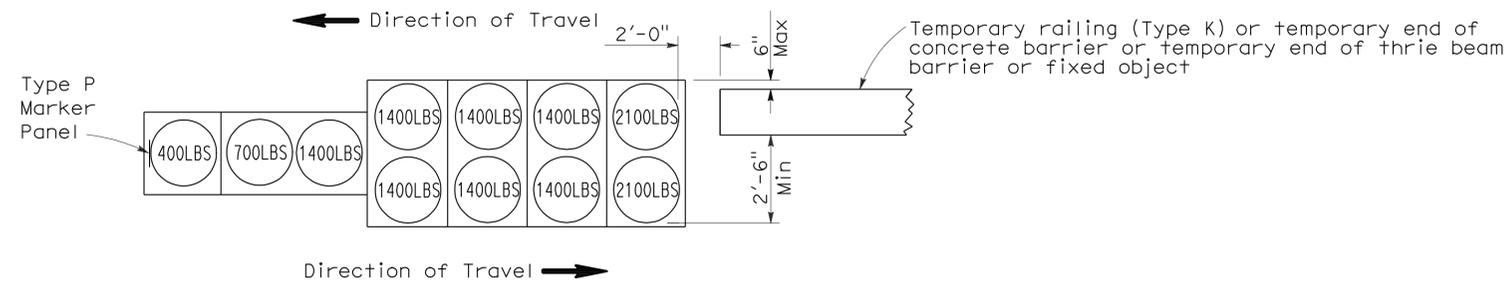


ARRAY 'TB11'

Approach speed less than 45 mph

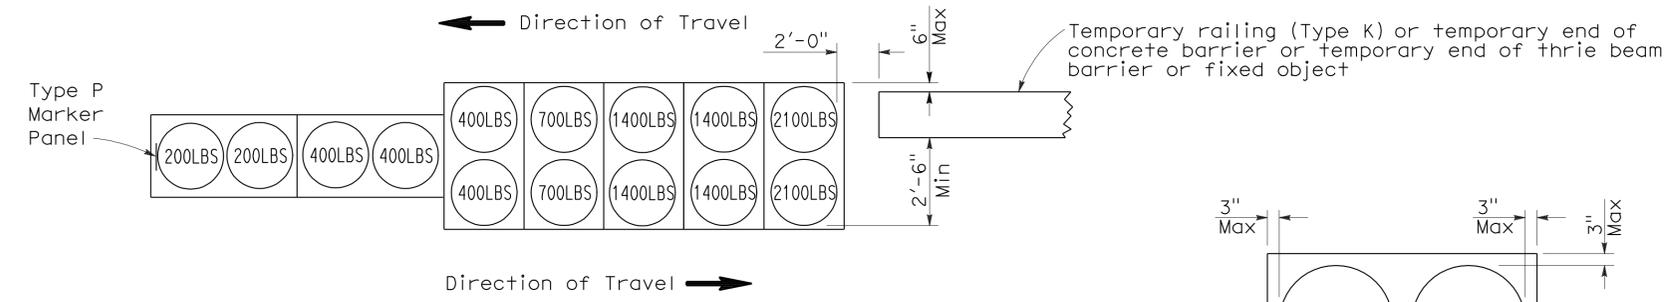


ARRAY 'TB14'

Approach speed 45 mph or more

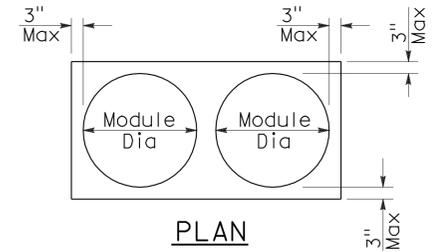

PLAN

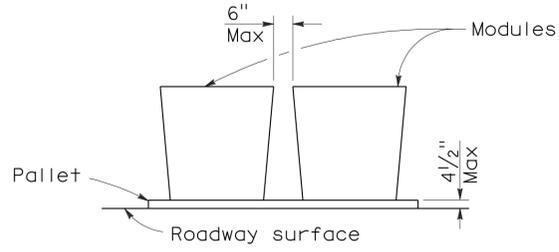

ELEVATION

CRASH CUSHION PALLET DETAIL

See Note 7

NOTES:

1. (XXX) Indicates sand filled module location and weight of sand in pounds for each module. Module spacing is based on the greater diameter of the module.
2. All sand weights are nominal.
3. Temporary crash cushion arrays shall not encroach on the traveled way.
4. Place the Type P marker panel so that the bottom of the panel rests upon the pallet.
5. Refer to Standard Plan A73B for marker details.
6. Approach speeds indicated conform to NCHRP 350 Report criteria.
7. Use of pallets is optional.

STATE OF CALIFORNIA
DEPARTMENT OF TRANSPORTATION

**TEMPORARY CRASH CUSHION,
SAND FILLED
(BIDIRECTIONAL)**

NO SCALE

RSP T1B DATED JUNE 6, 2008 SUPERSEDES STANDARD PLAN T1B
DATED MAY 1, 2006 - PAGE 212 OF THE STANDARD PLANS BOOK DATED MAY 2006.

REVISED STANDARD PLAN RSP T1B

2006 REVISED STANDARD PLAN RSP T1B


DIST	COUNTY	ROUTE	POST MILES TOTAL PROJECT	SHEET NO.	TOTAL SHEETS
08	SBd	5712		4	22

Randell D. Hiatt
REGISTERED CIVIL ENGINEER


June 6, 2008
PLANS APPROVAL DATE

The State of California or its officers or agents shall not be responsible for the accuracy or completeness of electronic copies of this plan sheet.

To accompany plans dated 12-24-12

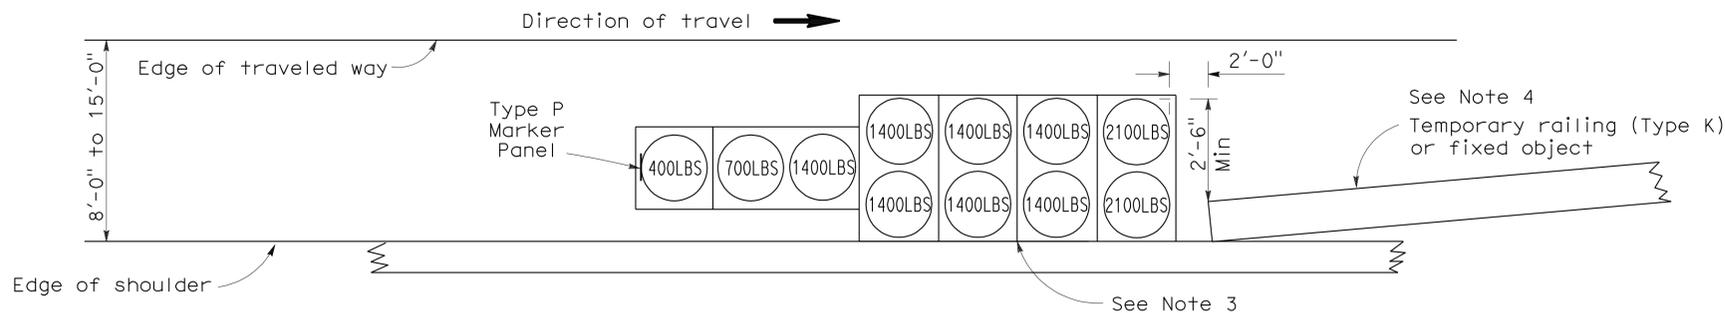


ARRAY 'TS11'
Approach speed less than 45 mph
See Note 9

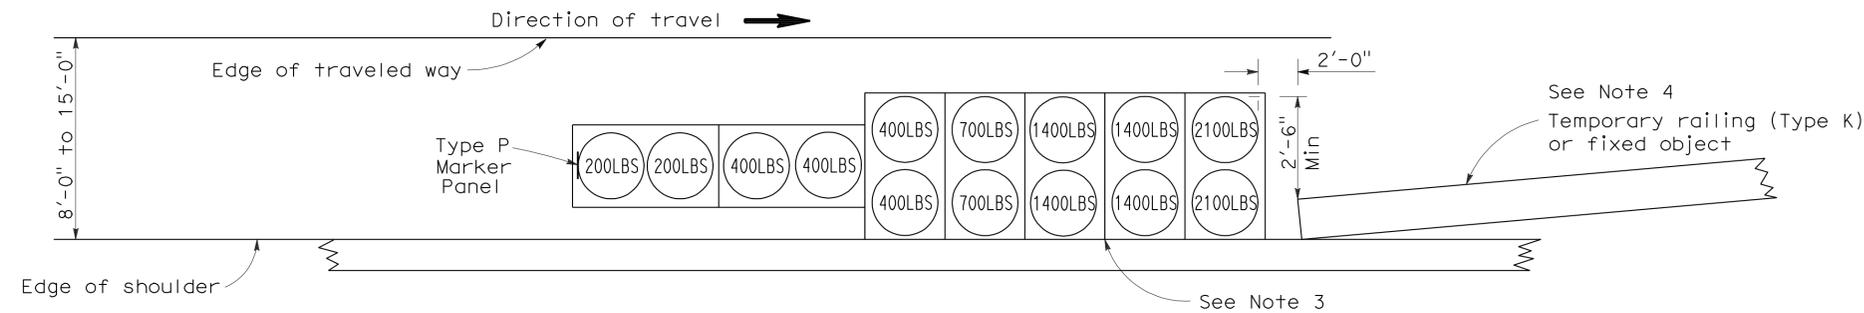

ARRAY 'TS14'
Approach speed 45 mph or more
See Note 9

NOTES:

- (XXX) Indicates sand filled module location and weight of sand in pounds for each module. Module spacing is based on the greater diameter of the module.
- All sand weights are nominal.
- The temporary crash cushion arrays shown on this plan shall be used only in locations where there will be traffic on one side of the temporary crash cushion array.
- If the fixed object or approach end of the temporary railing is less than 15'-0" from the edge of traveled way, a temporary crash cushion is required in a construction or work zone.
- Temporary crash cushion arrays shall not encroach on the traveled way.
- Arrays for median shoulders shall conform to details shown on this plan for outside shoulders.
- Place the Type P marker panel so that the bottom of the panel rests upon the pallet and faces traffic.
- Refer to Standard Plan A73B for marker details.
- For shoulder widths less than 8'-0", appropriate approved crash cushion protection, other than sand filled modules, shall be provided at fixed objects and at approach ends of temporary railing. The specific type of crash cushion shall be as shown on the project plans or as specified in the Special Provisions, or if not shown on the project plans or specified in the Special Provisions, shall be as approved by the Engineer.
- Approach speeds indicated conform to NCHRP 350 Report criteria.
- Use of pallets is optional.

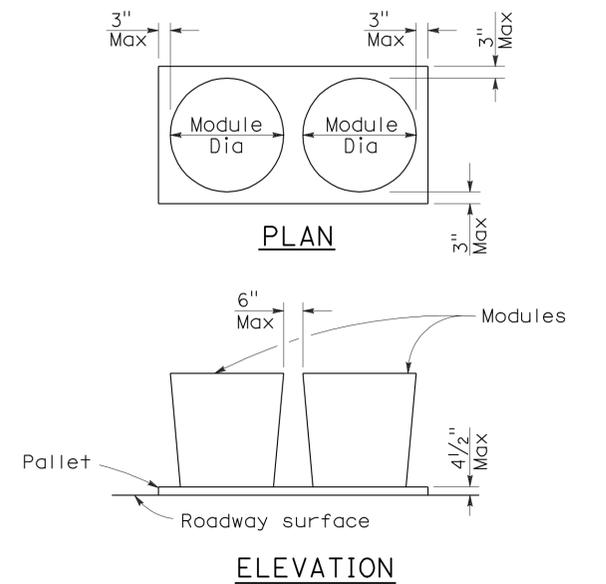

CRASH CUSHION PALLET DETAIL
See Note 11

STATE OF CALIFORNIA
DEPARTMENT OF TRANSPORTATION
**TEMPORARY CRASH CUSHION,
SAND FILLED
(SHOULDER INSTALLATIONS)**

NO SCALE
RSP T2 DATED JUNE 6, 2008 SUPERSEDES STANDARD PLAN T2
DATED MAY 1, 2006 - PAGE 213 OF THE STANDARD PLANS BOOK DATED MAY 2006.

REVISED STANDARD PLAN RSP T2

2006 REVISED STANDARD PLAN RSP T2


Dist	COUNTY	ROUTE	POST MILES TOTAL PROJECT	SHEET No.	TOTAL SHEETS
08	SBd	5712		5	22

Randell D. Hiatt
REGISTERED CIVIL ENGINEER


May 20, 2011
PLANS APPROVAL DATE

The State of California or its officers or agents shall not be responsible for the accuracy or completeness of electronic copies of this plan sheet.

To accompany plans dated 12-24-12

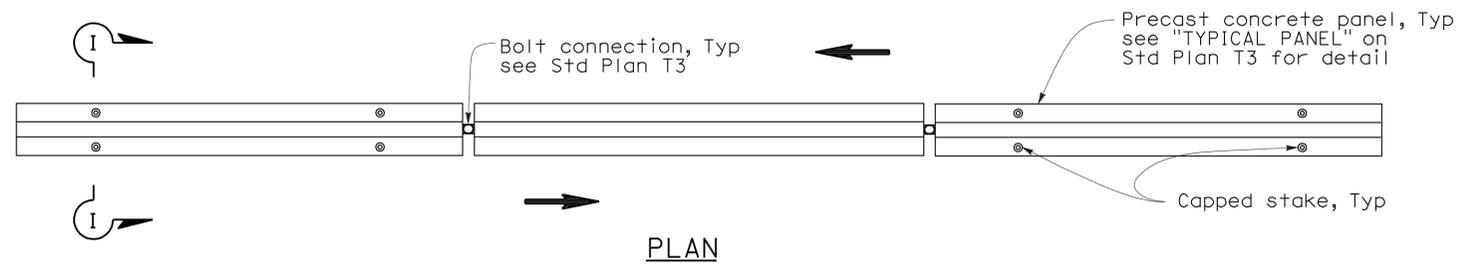


RAILING STAKING CONFIGURATION FOR TWO-WAY TRAFFIC
See Note 1


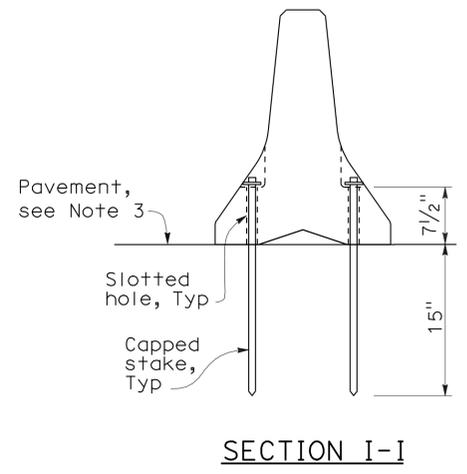


NOTES:

1. Where Type K Temporary Railing is placed as a temporary or long term barrier in two-way traffic on highways with less than 24" from the edge of traveled way, use four capped stakes per every other panel with end panels staked.
2. Where Type K Temporary Railing is placed 3" to 24" from the edge of an excavation on highways, use two capped stakes per panel along the traffic side.
3. Staked Type K Temporary Railing must be supported by at least 4" thick concrete, hot mix asphalt or existing asphalt concrete pavement.
4. The minimum yield strength for the washer must be 60,000 psi.
5. Direction of adjacent traffic indicated by \Rightarrow .

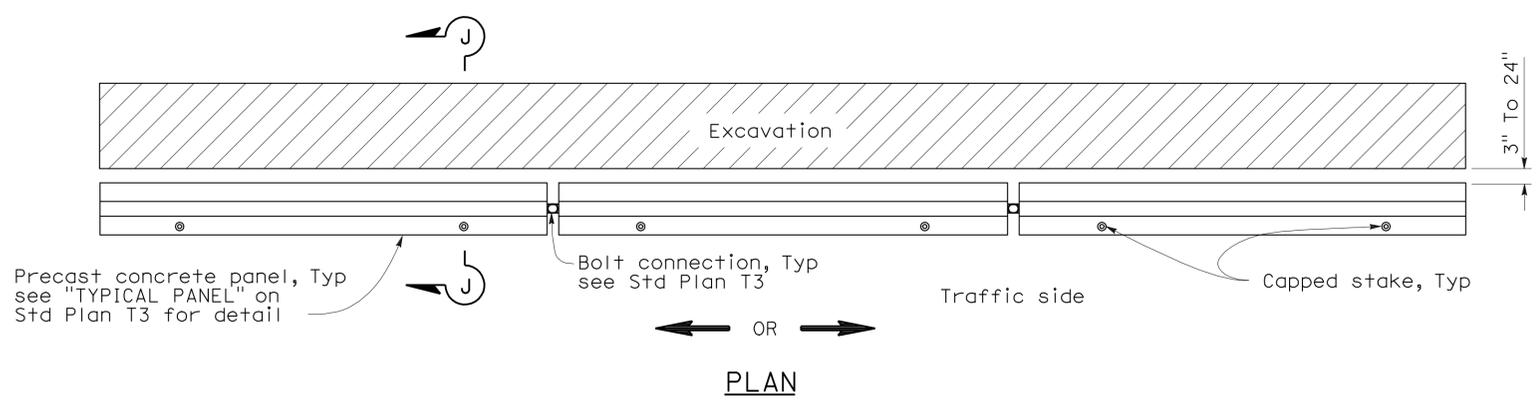

RAILING STAKING CONFIGURATION ADJACENT TO AN EXCAVATION
See Note 2

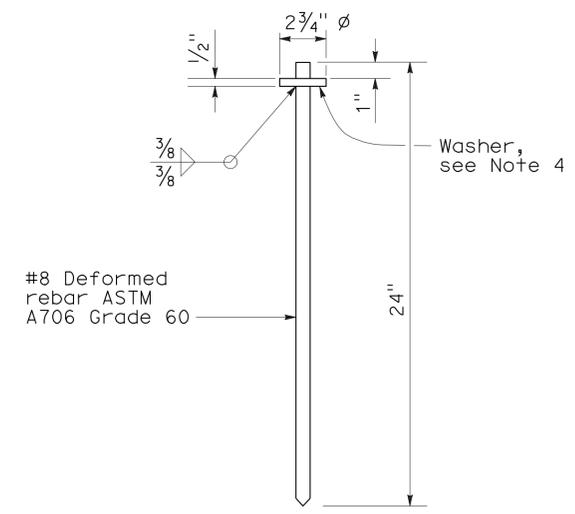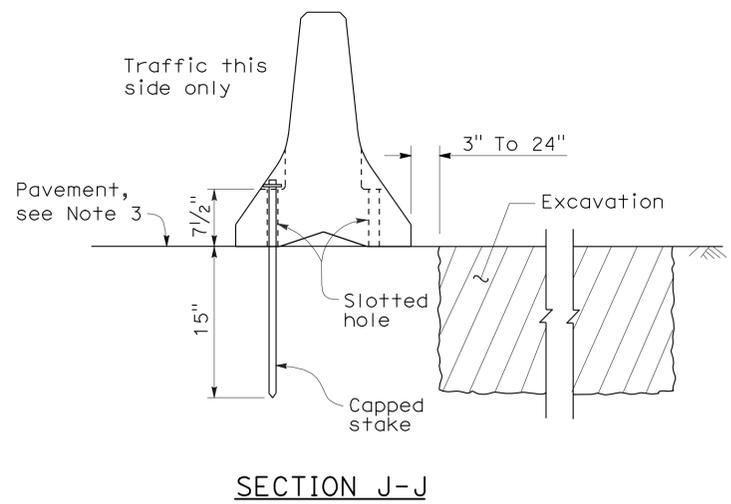

STATE OF CALIFORNIA
DEPARTMENT OF TRANSPORTATION
**TEMPORARY RAILING
(TYPE K)**
NO SCALE

NSP T3A DATED MAY 20, 2011 SUPPLEMENTS
THE STANDARD PLANS BOOK DATED MAY 2006.

2006 NEW STANDARD PLAN NSP T3A

INDEX OF SHEETS


SHEET NO. DESCRIPTION
 GP EXISTING GENERAL PLAN

MECHANICAL PLANS

- M-0 MECHANICAL LEGEND
- M-1 MECHANICAL SITE PLAN
- M-2 CNG EQUIPMENT LAYOUT
- M-3 COMPRESSOR DETAILS
- M-4 GAS DRYER DETAILS
- M-5 MECHANICAL DETAILS NO. 1
- M-6 MECHANICAL DETAILS NO. 2

ELECTRICAL PLANS

- EE-0 LEGEND
- EE-1 EXISTING SITE PLAN
- EE-2 MODIFIED SITE PLAN
- EE-3 EXISTING MAIN SWITCHBOARD
- EE-4 MODIFIED MAIN SWITCHBOARD
- EE-5 EXISTING GAS HOUSE
- EE-6 ENLARGED CNG STATION POWER PLAN
- EE-7 PANEL FW DETAILS
- EE-8 DETAILS

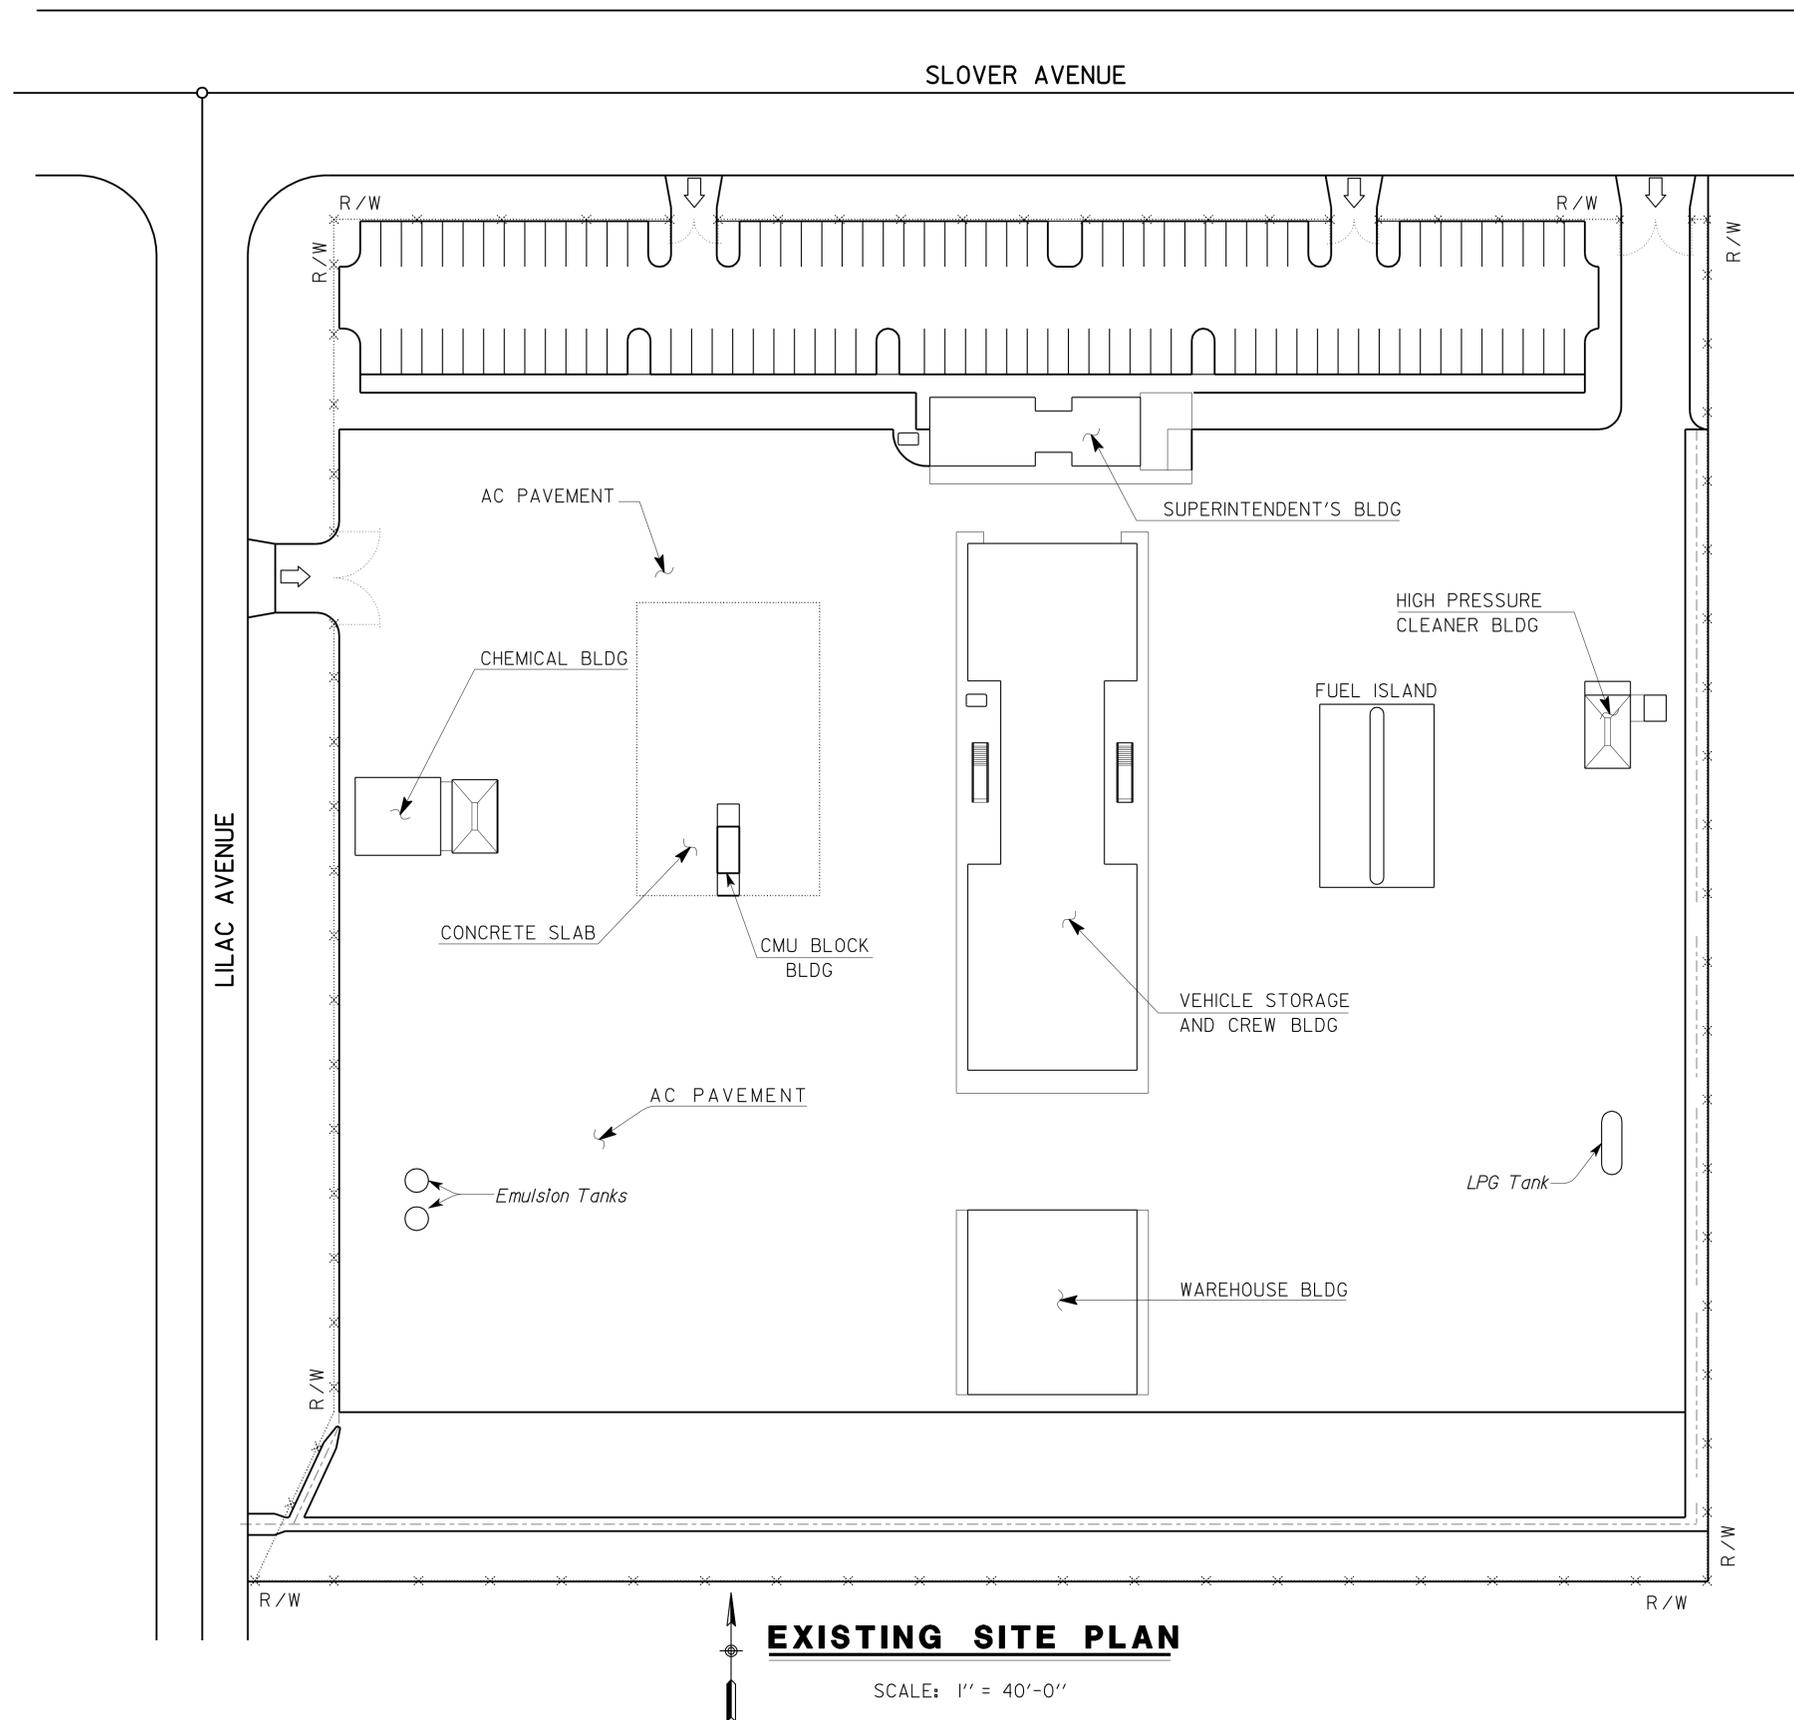

EXISTING SITE PLAN


SCALE: 1" = 40'-0"

DIST	COUNTY	LOCATION CODE	POST MILES TOTAL PROJECT	SHEET No.	TOTAL SHEETS
08	SBd	5712		6	22

Mark Hedglin 5-7-12
 REGISTERED ENGINEER-MECHANICAL

12-24-12
 PLANS APPROVAL DATE

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Fire Marshal Stamp

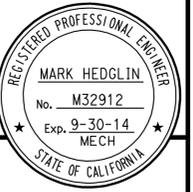CALIFORNIA STATE FIRE MARSHAL APPROVED

Approval of this plan does not authorize or approve any addition or deviation from applicable regulations. Final approval is subject to fire inspection. One set of approved plans shall be available on the project site at all times.

Reviewed by: *Francis Solich*
 FRANCIS SOLICH
 Date: 4/30/12

CSFM File Number: 01-36-11-0012

APPLICABLE CODES

- 2010 California Building Code (CBC) Title 24, Part 2 CCR
- 2010 California Electrical Code (CEC) Title 24, Part 3 CCR
- 2010 California Fire Code (CFC) Title 24, Part 9 CCR
- 2010 California Mechanical Code (CMC) Title 24, Part 4 CCR
- NFPA 30A 2012 Edition
- NFPA 52 2012 Edition
- 2010 Americans with Disabilities Act (ADA)

Note:

For accurate right of way and access data, contact right of way engineering at the district office.

Tom Hatam
 DESIGN SUPERVISOR

Mark Hedglin
 DESIGN ENGINEER

DESIGN	BY Mark Hedglin	CHECKED Tom Hatam
DETAILS	BY Rudy Sarte	CHECKED Mark Hedglin
QUANTITIES	BY Mark Hedglin	CHECKED Tom Hatam

STATE OF CALIFORNIA
 DEPARTMENT OF TRANSPORTATION

DIVISION OF ENGINEERING SERVICES
 ELECTRICAL-MECHANICAL-WATER AND WASTEWATER DESIGN

BRIDGE No. _____
 POST MILE _____

MAGANA-ORTEGA MS

EXISTING GENERAL PLAN

SHEET **GP** OF _____

USERNAME => s121614 DATE PLOTTED => 16-JAN-2013 TIME PLOTTED => 05:35

DIST	COUNTY	LOCATION CODE	POST MILES TOTAL PROJECT	SHEET No.	TOTAL SHEETS
08	SBd	5712		7	22

Mark Hedglin 5-7-12
 REGISTERED ENGINEER-MECHANICAL

REG. NO. M32912
 Exp. 9-30-14
 MECH
 STATE OF CALIFORNIA

12-24-12
 PLANS APPROVAL DATE

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PLUMBING

- — — — — Cold Water
- A — — — Compressed Air
- G — — — Gas
- D — — — Equipment Drain
- F — — — Fire Water
- — — — — Hot Water
- — — — — Hot Water Return
- LPG — — — Liquefied Petroleum Gas
- R — — — Relief Valve Discharge Pipe
- SS — — — Sanitary Sewer
- — — — — Sanitary Sewer (above grade)
- — — — — Sanitary Sewer (below grade)
- — — — — Sanitary Sewer Vent

PIPE FITTINGS AND VALVES

- — — — — Cap, Threaded
- G — — — Elbow, Turned Down
- ⊙ — — — Elbow, Turned Up
- — — — — Reducer, Concentric
- ⊙ — — — Pressure Gauge (with Valve and Snubber)
- — — — — Strainer
- — — — — Union
- — — — — Union, Insulating
- ⊙ — — — Valve, Ball
- Z — — — Valve, Check
- — — — — Valve, Gas
- — — — — Valve, Gate
- — — — — Valve, Safety Relief
- ⊙ — — — Valve, Pressure Reducing
- — — — — Valve, Pressure/Temperature Relief
- — — — — Water Hammer Arrestor

MECHANICAL ABBREVIATIONS:

- | | | | | | |
|------|---------------------------------|------|---|------|--------------------------------|
| A/C | Air Conditioning | GA | Gauge | R | Radius |
| ABS | Acrylonitrile Butadiene Styrene | GALV | Galvanized | REG | Register |
| AC | Asphalt Concrete | GLV | Globe Valve | RA | Return Air |
| AD | Air Drop | GPM | Gallons Per Minute | RCP | Reinforced Concrete Pipe |
| AP | Alternative Pipe | GSP | Galvanized Steel Pipe | REQ | Required |
| ATF | Automatic Transmisston Fluid | GV | Gate Valve | RH | Radiant Heater |
| AWG | American Wire Gauge | GYP | Gypsum | RV | Relief Valve |
| BFP | Backflow Preventer | H | Height | S/S | Service Sink |
| BLDG | Building | HB | Hydrant Box | SA | Supply Air |
| BTU | British Thermal Unit | H/C | Hot Water, High Pressure Cleaner | SCFM | Standard Cubic Feet per Minute |
| BTUH | British Thermal Unit Per Hour | HF | Hose Faucet | SCH | Schedule |
| BV | Balancing Valve | HVAC | Heating, Ventilating And Air Conditioning | SDS | Sanitary Dump Station |
| C | Conduit | HW | Hot Water | SF | Supply Fan |
| CD | Ceiling Diffuser | HZ | Hertz | SHR | Shower |
| CFM | Cubic Feet Per Minute | ID | Inside Diameter | SP | Static Pressure |
| CI | Cast-Iron | IE | Invert Elevation | SS | Sanitary Sewer |
| CNG | Compressed Natural Gas | IN | Inch | STA | Station |
| CO | Cleanout | IPS | International Pipe Standard | STD | Standard |
| COTF | Cleanout Through Floor | KS | Kitchen Sink | TCV | Temperature Control Valve |
| COTG | Cleanout Through Grade | LAV | Lavatory | TOT | Total |
| COTW | Cleanout To Wall | LPG | Liquefied Petroleum Gas | TP | Trap Primer |
| CV | Check Valve | LS | Lab Sink | TS | Time Switch |
| CW | Cold Water | LS | Lab Sink | TYP | Typical |
| D | Depth | MAX | Maximum | UH | Unit Heater |
| DB | Dry Bulb | MAN | Manhole | URI | Urinal |
| DF | Drinking Fountain | MIN | Minimum | V | Vent |
| DH | Duct Heater | NFPA | National Fire Protection Association | VAC | Voltage, Alternating Current |
| DIA | Diameter | NIC | Not In Contract | VR | Vent Riser |
| (E) | Existing | NO | Number | VTR | Vent Thru Roof |
| EA | Exhaust Air | NPT | National Pipe Thread | W | Width |
| EEW | Emergency Eyewash | NST | National Standard Thread | W/ | With |
| EF | Exhaust Fan | OA | Outside Air | W/O | Without |
| EL | Elevation | OC | On Center | WB | Wet Bulb |
| EWC | Electric Water Cooler | OD | Outside Diameter | WC | Water Closet |
| EWB | Electric Water Heater | OG | Original Ground | W.C. | Water Column |
| FC | Flexible Connection | PCC | Portland Cement Concrete | WH | Wall Heater |
| FD | Floor Drain | PDS | Pressure Differential Switch | WHA | Water Hammer Arrestor |
| FDC | Fire Department Connection | PH | Phase | WLS | Water Level Switch |
| FE | Fire Extinguisher | PRV | Pressure Reducing Valve | WP | Weatherproof |
| FG | Finish Grade | PSI | Pounds Per Square Inch | WS | Wash Sink |
| FH | Fire Hydrant | PVC | Polyvinyl Chloride | WSP | Welded Steel Pipe |
| FL | Flow Line | | | | |
| FTR | Flue Through Roof | | | | |
| FS | Flow Switch | | | | |

Fire Marshal Stamp

CALIFORNIA STATE FIRE MARSHAL
 APPROVED

Approval of this plan does not authorize or approve any omission or deviation from applicable regulations. Final approval is subject to field inspection. One set of approved plans shall be available on the project site at all times.

Reviewed by: *Francis Solich*
 FRANCIS SOLICH
 Date: 4/30/12

HEATING, VENTILATING AND AIR CONDITIONING

- — — — — Balance Damper
- — — — — Flexible Duct
- EA — — — Exhaust Air
- RA — — — Return Air
- SA — — — Supply Air
- ER or [] or [] CFM/ER
CFM Exhaust Register
- [] or [] SIZE
CFM Return
- ← [] or [] SIZE
CFM Supply Diffuser
- ⊙ Thermostat
- ⊙ TS Time Switch
- ▲ Anode Test Station
- △ Three Wire Test Station
- ⊙ EF Exhaust Fan
- ⊙ FE Fire Extinguisher
- ⊙ BC Bypass Controller

MISCELLANEOUS

- L Angle
- ⊕ Centerline
- ∅ Diameter
- Section / Elevation Letter
- Sheet Number
- Detail Number
- Sheet Number

THIS DRAWING ACCURATE FOR MECHANICAL WORK ONLY

DESIGN BY <i>Mark Hedglin</i> CHECKED <i>Tom Hatam</i>	STATE OF CALIFORNIA DEPARTMENT OF TRANSPORTATION	DIVISION OF ENGINEERING SERVICES ELECTRICAL-MECHANICAL-WATER AND WASTEWATER DESIGN	BRIDGE No.	MAGANA-ORTEGA MS MECHANICAL LEGEND	SHEET M-0	
DETAILS BY <i>Rudy Sarte</i> CHECKED <i>Mark Hedglin</i>		PROJECT NUMBER & PHASE 08000004541	POST MILE		REVISION DATES (PRELIMINARY STAGE ONLY)	SHEET OF
QUANTITIES BY <i>Mark Hedglin</i> CHECKED <i>Tom Hatam</i>		UNIT 3580	DISREGARD PRINTS BEARING EARLIER REVISION DATES		05-08-10 06-02-10 06-30-10 07-28-10 08-25-10 09-22-10 11-08-10 12-08-10 3-6-12 12-4-12	


FILE => m_0.dgn DATE PLOTTED => 16-JAN-2013 TIME PLOTTED => 05:35 ORIGINAL SCALE IN INCHES FOR REDUCED PLANS 0 1 2 3

DIST	COUNTY	LOCATION CODE	POST MILES TOTAL PROJECT	SHEET No.	TOTAL SHEETS
08	SBd	5712		8	22


 REGISTERED ENGINEER-MECHANICAL 5-7-12


12-24-12
 PLANS APPROVAL DATE
 The State of California or its officers or agents shall not be responsible for the accuracy or completeness of scanned copies of this plan sheet.

Fire Marshal Stamp
CALIFORNIA STATE FIRE MARSHAL APPROVED
Approval of this plan does not authorize or approve any omission or deviation from applicable regulations. Final approval is subject to field inspection. One set of approved plans shall be available on the project site at all times.
 Reviewed by: 
 FRANCIS SOLICH
 Date: 4/30/12

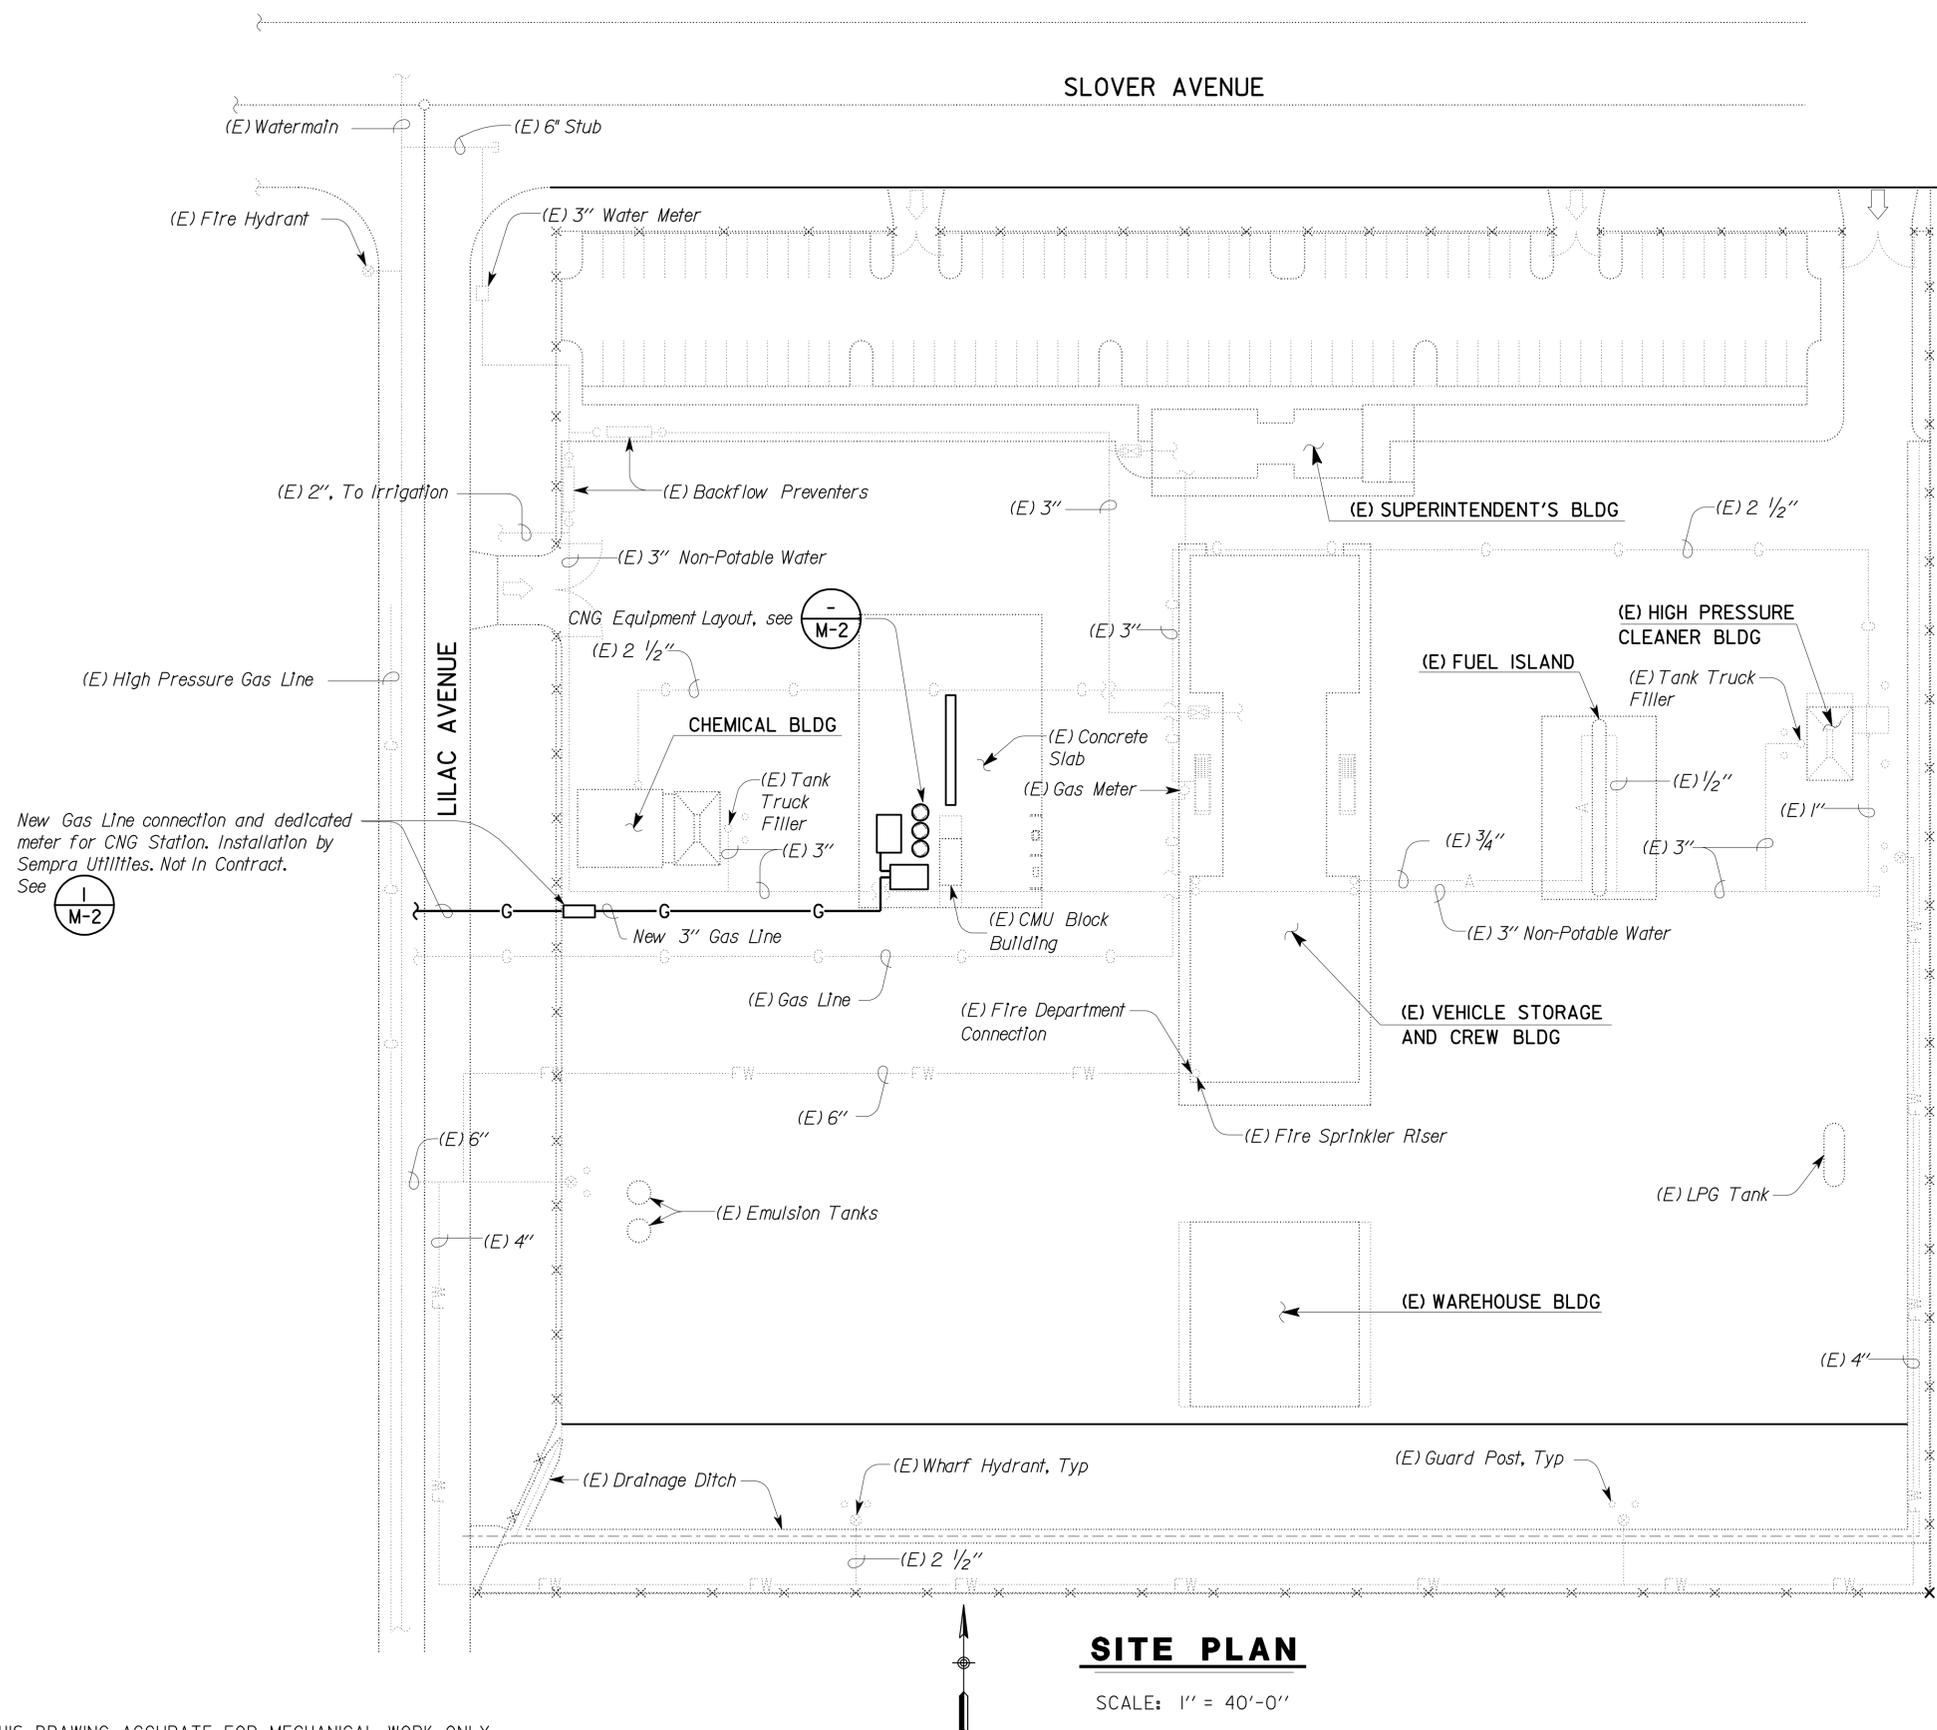

SITE PLAN
 SCALE: 1" = 40'-0"

- Notes:
- The Contractor shall verify all controlling field dimensions before order or fabricating any material.
 - The Contractor shall verify and locate (E) underground utility lines prior to working below grade.

THIS DRAWING ACCURATE FOR MECHANICAL WORK ONLY

DS OSD 2139A (4/89) FILE NO.:	FILE => m_1.dgn DATE PLOTTED => 16-JAN-2013 TIME PLOTTED => 05:35	DESIGN BY <i>Mark Hedglin</i> CHECKED <i>Tom Hatam</i>	STATE OF CALIFORNIA DEPARTMENT OF TRANSPORTATION	DIVISION OF ENGINEERING SERVICES ELECTRICAL-MECHANICAL-WATER AND WASTEWATER DESIGN	BRIDGE No.	MAGANA-ORTEGA MS MECHANICAL SITE PLAN	SHEET M-1 OF
		DETAILS BY <i>Rudy Sarte</i> CHECKED <i>Mark Hedglin</i>			POST MILE		REVISION DATES (PRELIMINARY STAGE ONLY) 05-08-10 06-02-10 06-30-10 07-28-10 08-25-10 09-22-10 11-08-10 12-08-10 3-6-12 12-4-12
		QUANTITIES BY <i>Mark Hedglin</i> CHECKED <i>Tom Hatam</i>	UNIT PROJECT NUMBER & PHASE 3580 08000004541		DISREGARD PRINTS BEARING EARLIER REVISION DATES		SHEET OF

USERNAME => s121614 DATE PLOTTED => 16-JAN-2013 TIME PLOTTED => 05:35


DIST	COUNTY	LOCATION CODE	POST MILES TOTAL PROJECT	SHEET No.	TOTAL SHEETS
08	SBd	5712		9	22

12-08-10
 REGISTERED ENGINEER-MECHANICAL
 MARK HEDGLIN
 No. M32912
 Exp. 9-30-14
 MECH
 STATE OF CALIFORNIA

12-24-12
 PLANS APPROVAL DATE

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- Notes:**
1. Accessible route of travel to Fuel Control Terminal needs not be identified on the plan as any vehicles may park next to the Clear Level Area by the Fuel Control Terminal.
 2. Install Bleeder Valves on valves and filters regularly removed for service.

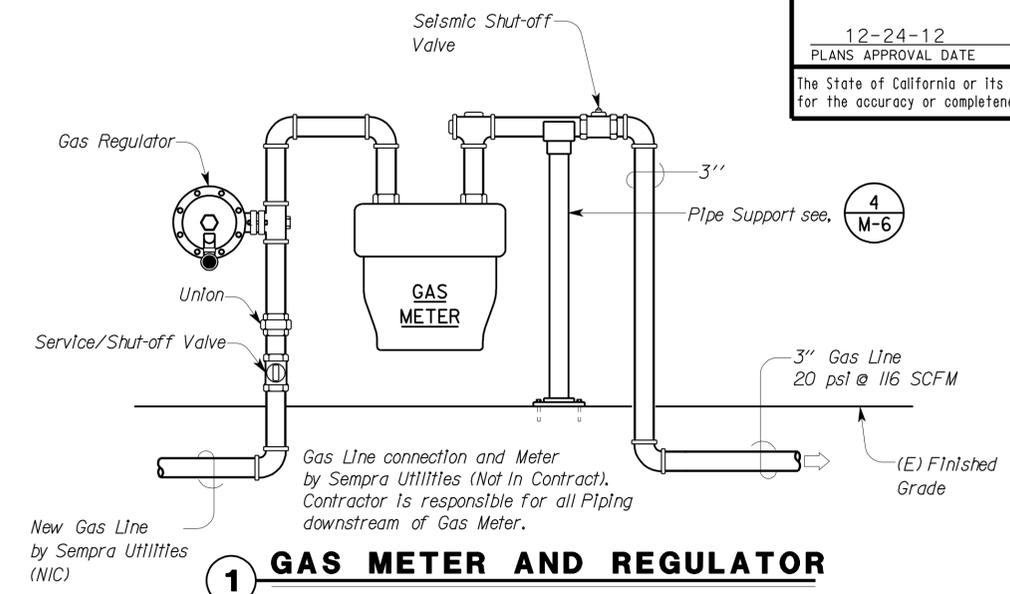

Fire Marshal Stamp

CALIFORNIA STATE FIRE MARSHAL APPROVED


Approval of this plan does not authorize or approve any omission or deviation from applicable regulations. Final approval is subject to field inspection. One set of approved plans shall be available on the project site at all times.

Reviewed by: FRANCIS SOLICH
Date: 4/30/12

ACCESSIBILITY DESIGN APPROVAL STAMP
DOT / DES / OTA

PROJECT ID: **080000454**


Reviewed by: YA-WANG
Date: 4/27/12

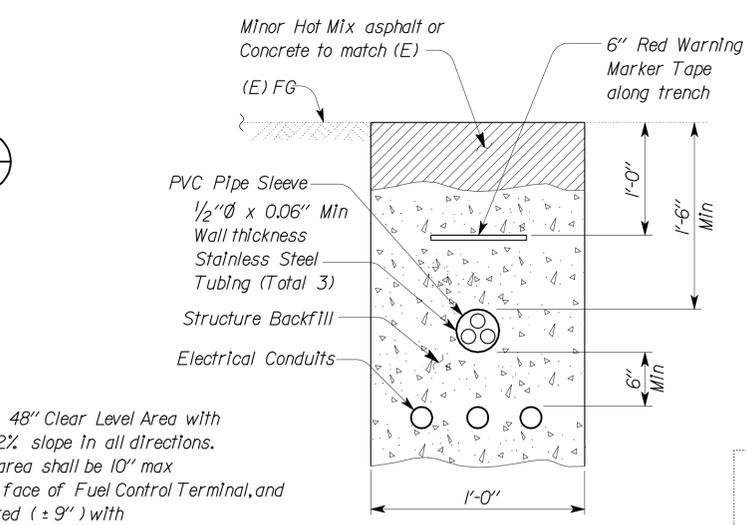

3 WARNING SIGN
NO SCALE

NO SMOKING.
FLAMMABLE GAS.

- 4 WARNING SIGN**
NO SCALE
- A. STOP MOTOR.
 - B. NO SMOKING.
 - C. FLAMMABLE GAS.
 - D. NATURAL GAS VEHICLE FUEL CYLINDERS SHALL BE PERIODICALLY INSPECTED (NORMALLY EVERY 3 YEARS) TO ENSURE SAFE OPERATION OF THE VEHICLE. CONTACT VEHICLE OR CYLINDER MANUFACTURER.

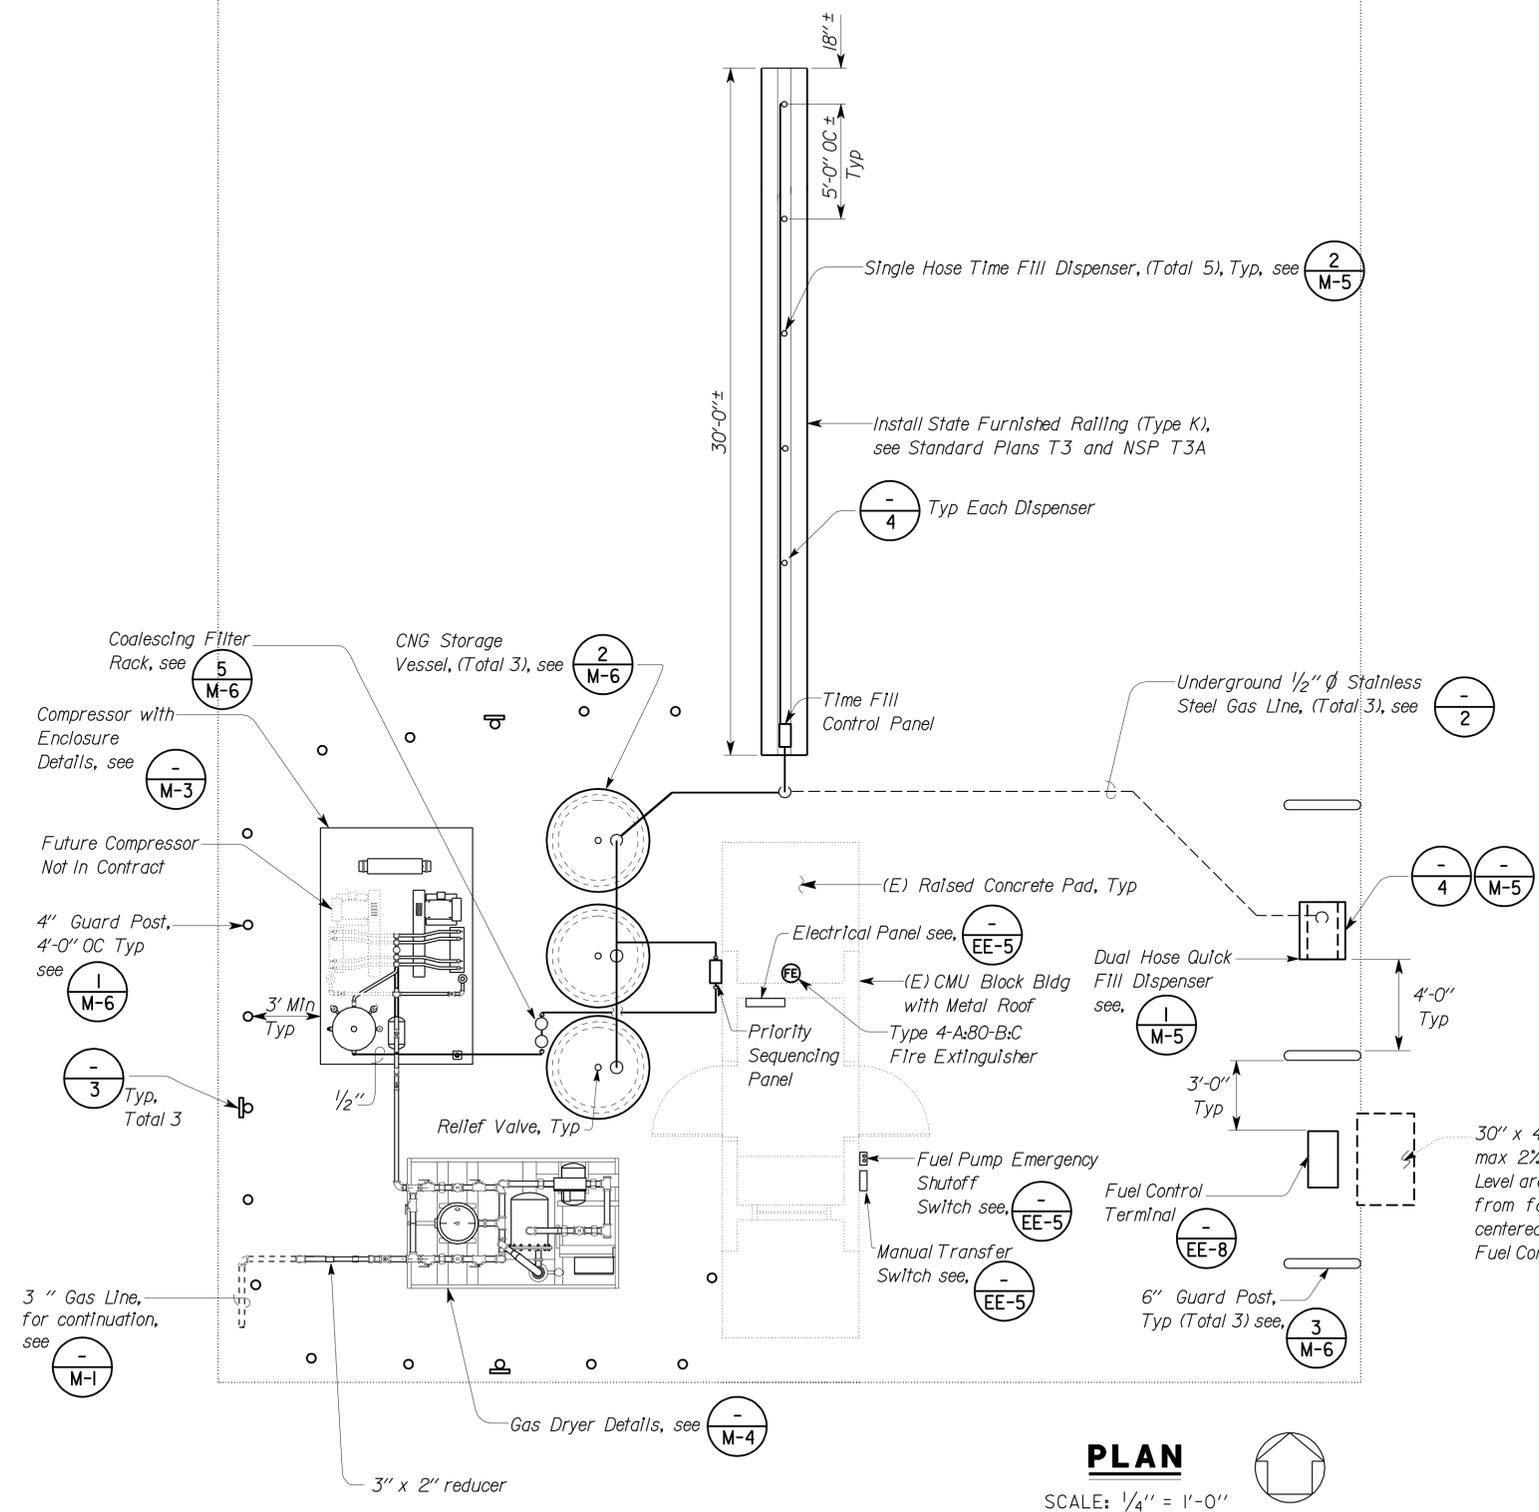

THIS DRAWING ACCURATE FOR MECHANICAL WORK ONLY		DESIGN BY: Mark Hedglin	CHECKED: Tom Hatam	STATE OF CALIFORNIA DEPARTMENT OF TRANSPORTATION	DIVISION OF ENGINEERING SERVICES ELECTRICAL-MECHANICAL-WATER AND WASTEWATER DESIGN	BRIDGE No.	MAGANA-ORTEGA MS CNG EQUIPMENT LAYOUT	SHEET
		DETAILS BY: Rudy Sarte	CHECKED: Mark Hedglin		PROJECT NUMBER & PHASE: 08000004541	POST MILE		OF
		QUANTITIES BY: Mark Hedglin	CHECKED: Tom Hatam		UNIT: 3580	DISREGARD PRINTS BEARING EARLIER REVISION DATES		REVISION DATES (PRELIMINARY STAGE ONLY)

DS OSD 2139A (4/89) FILE => m_2.dgn ORIGINAL SCALE IN INCHES FOR REDUCED PLANS 0 1 2 3
 DATE PLOTTED => 16-JAN-2013 TIME PLOTTED => 05:35
 EA 08-0M0204

DIST	COUNTY	LOCATION CODE	POST MILES TOTAL PROJECT	SHEET No.	TOTAL SHEETS
08	SBd	5712		10	22

Mark Hedglin 5-7-12
REGISTERED ENGINEER-MECHANICAL

REGISTERED PROFESSIONAL ENGINEER
MARK HEDGLIN
No. M32912
Exp. 9-30-14
MECH
STATE OF CALIFORNIA

12-24-12
PLANS APPROVAL DATE


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Fire Marshal Stamp



CALIFORNIA STATE FIRE MARSHAL APPROVED

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Reviewed by: *Francis Solich*
FRANCIS SOLICH
Date: 4/30/12



PLAN
NO SCALE

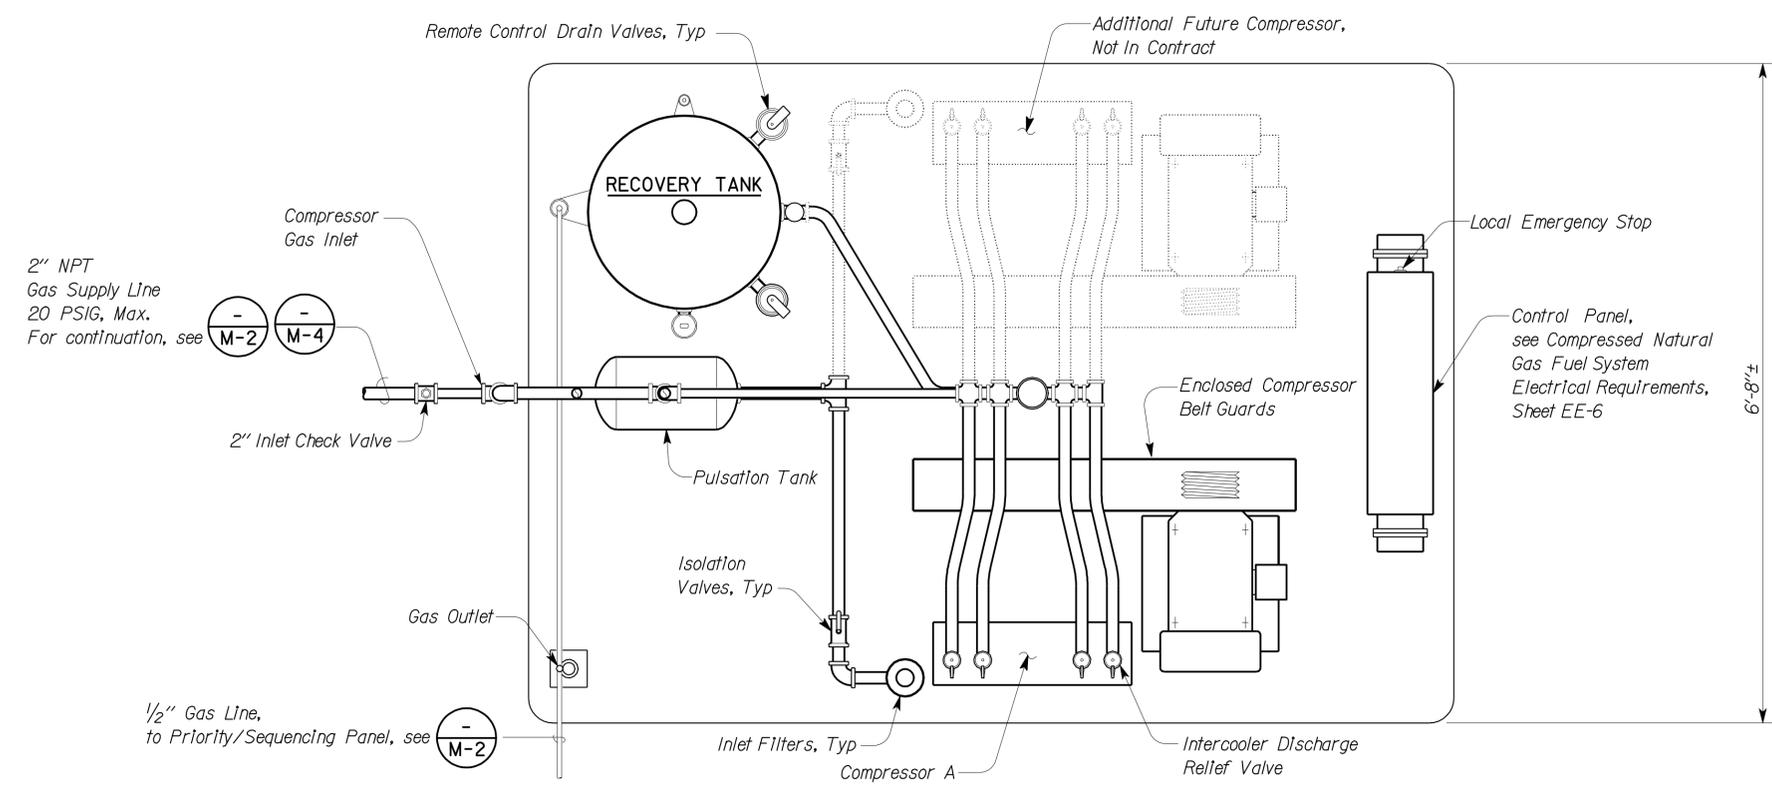

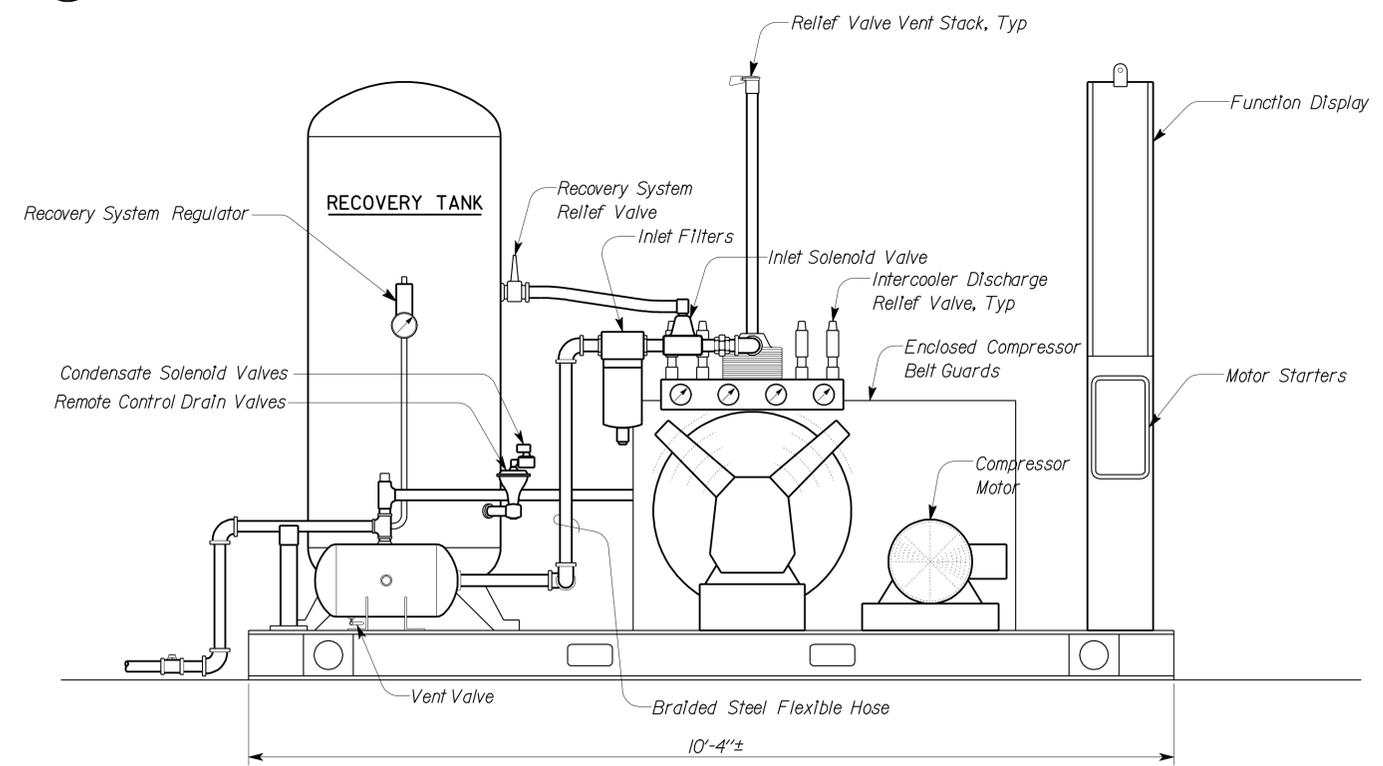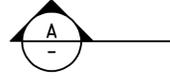A ELEVATION
NO SCALE

THIS DRAWING ACCURATE FOR MECHANICAL WORK ONLY

DS OSD 2139A (4/89) FILE NO.:	FILE => m_3.dgn DATE PLOTTED => 16-JAN-2013 TIME PLOTTED => 05:35	DESIGN BY <i>Mark Hedglin</i> CHECKED <i>Tom Hatam</i>	STATE OF CALIFORNIA DEPARTMENT OF TRANSPORTATION	DIVISION OF ENGINEERING SERVICES	BRIDGE No.	MAGANA-ORTEGA MS COMPRESSOR DETAILS	SHEET
		DETAILS BY <i>Rudy Sarte</i> CHECKED <i>Mark Hedglin</i>		ELECTRICAL-MECHANICAL-WATER AND WASTEWATER DESIGN	POST MILE		M-3
		QUANTITIES BY <i>Mark Hedglin</i> CHECKED <i>Tom Hatam</i>		UNIT PROJECT NUMBER & PHASE 3580 08000004541	DISREGARD PRINTS BEARING EARLIER REVISION DATES		OF
		ORIGINAL SCALE IN INCHES FOR REDUCED PLANS		REVISION DATES (PRELIMINARY STAGE ONLY)		SHEET OF	
		0 1 2 3		05-08-10 06-02-10 06-30-10 07-28-10 08-25-10 09-22-10 11-08-10 12-08-10 3-15-12 12-4-12			


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DIST	COUNTY	LOCATION CODE	POST MILES TOTAL PROJECT	SHEET No.	TOTAL SHEETS
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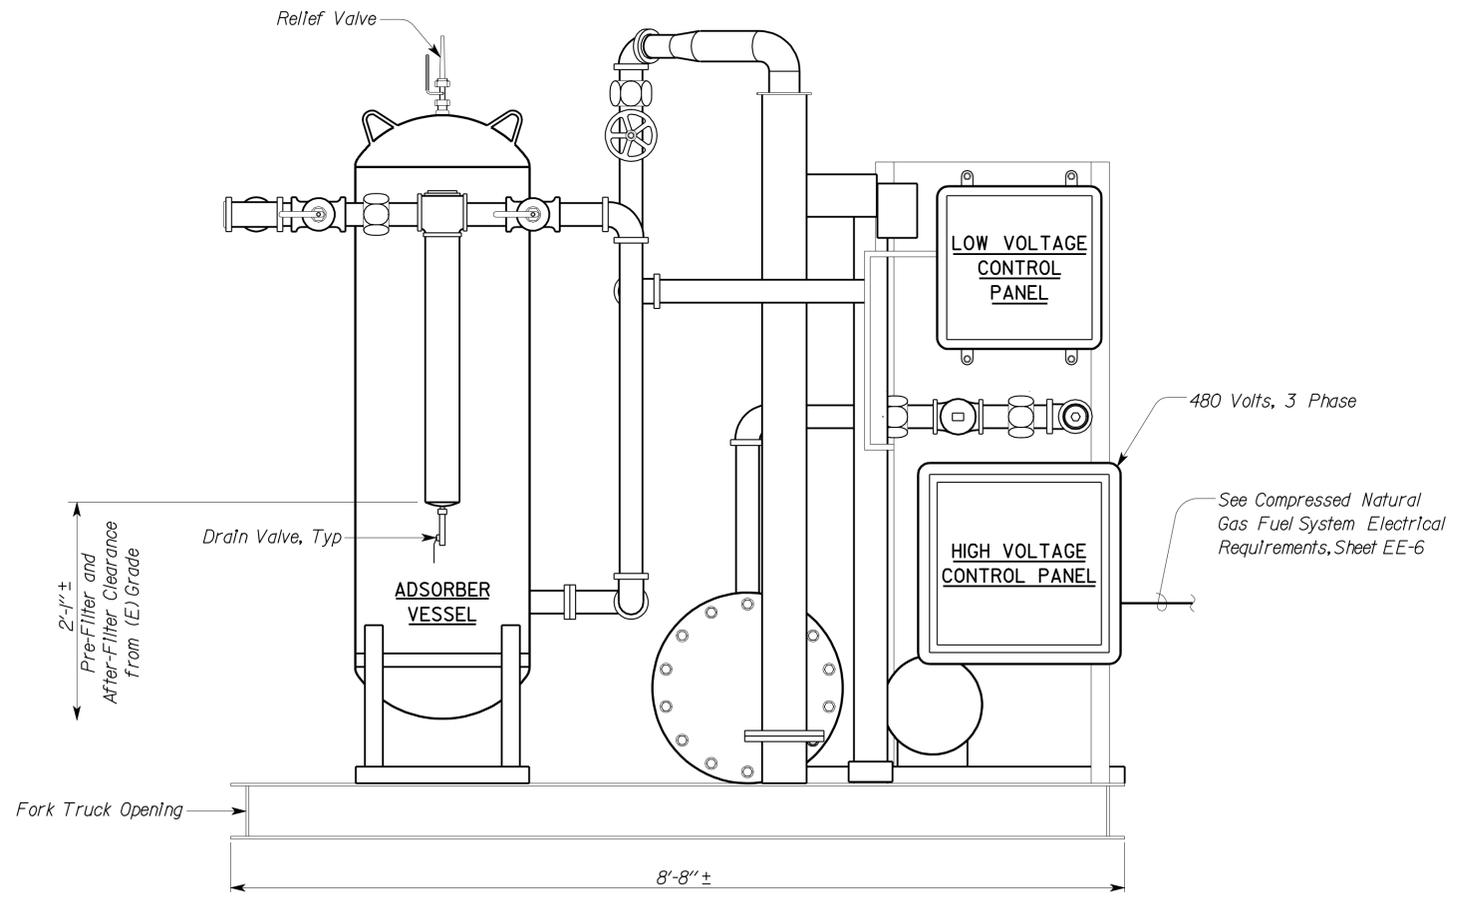

 REGISTERED ENGINEER-MECHANICAL 5-7-12
 No. M32912
 Exp. 9-30-14
 MECH
 STATE OF CALIFORNIA

12-24-12
 PLANS APPROVAL DATE
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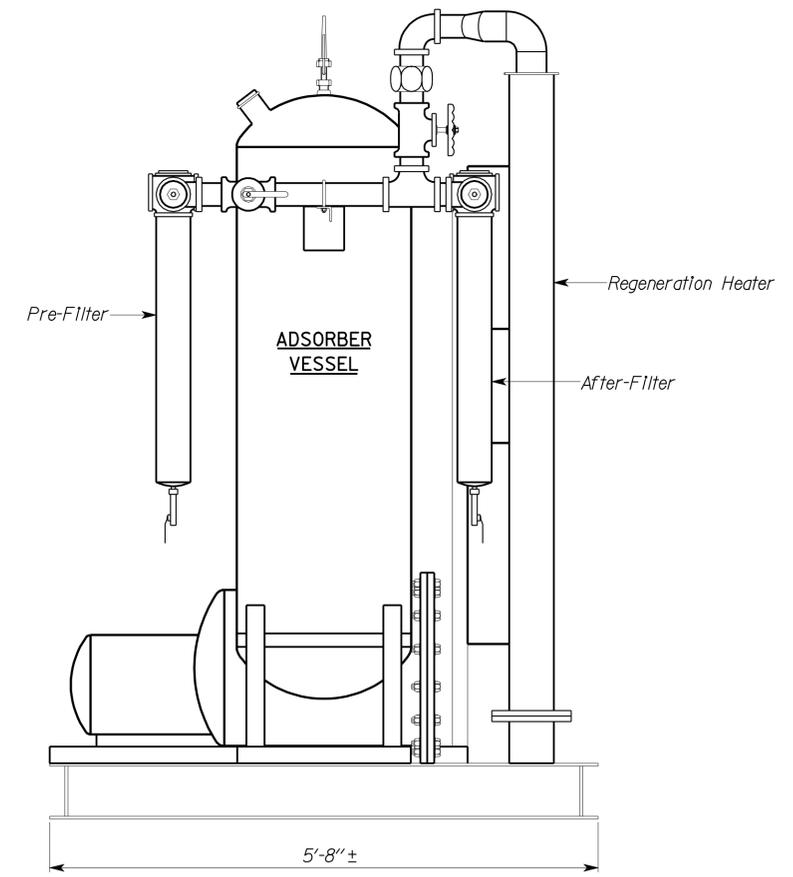
Fire Marshal Stamp
CALIFORNIA STATE FIRE MARSHAL APPROVED
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 Reviewed by: 
FRANCIS SOLICH
 Date: 4/30/12



PLAN
NO SCALE

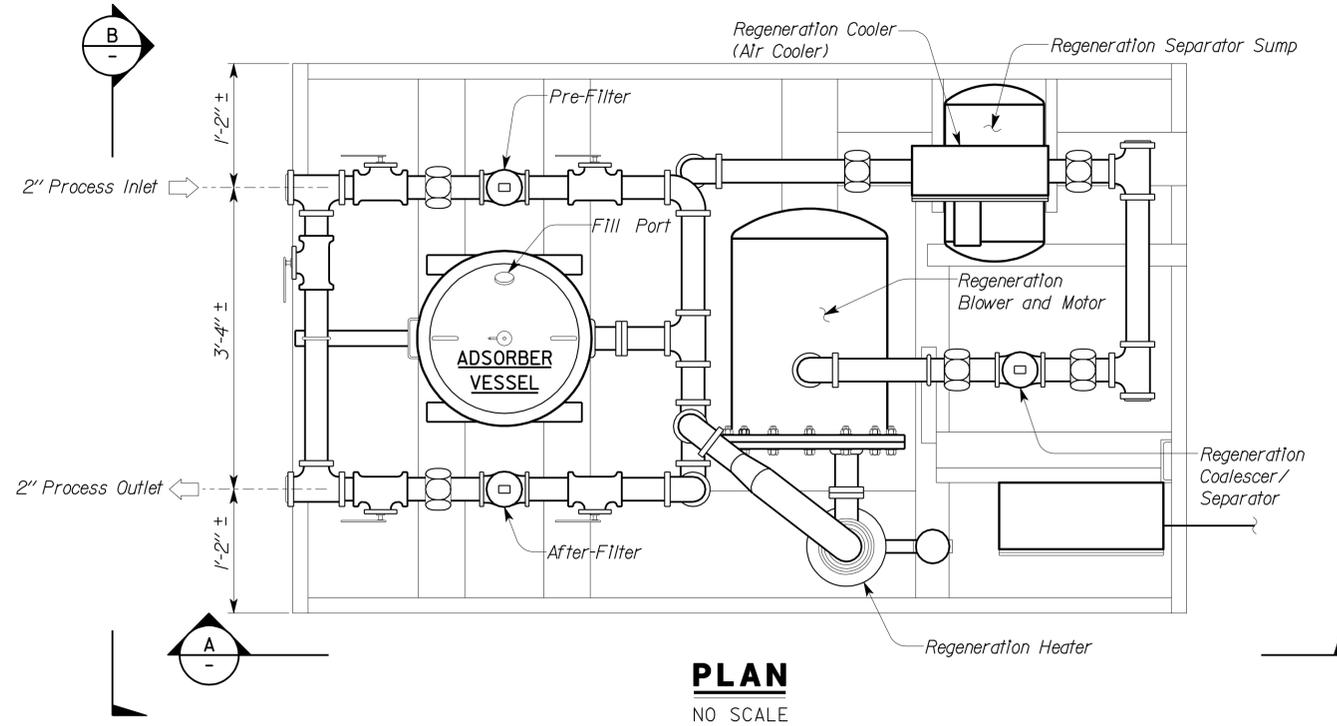

A ELEVATION
NO SCALE



B ELEVATION
NO SCALE

THIS DRAWING ACCURATE FOR MECHANICAL WORK ONLY

DS OSD 2139A (4/89) FILE NO.:	FILE => m_4.dgn DATE PLOTTED => 16-JAN-2013 TIME PLOTTED => 05:36	DESIGN BY <i>Mark Hedglin</i> CHECKED <i>Tom Hatam</i>	STATE OF CALIFORNIA DEPARTMENT OF TRANSPORTATION	DIVISION OF ENGINEERING SERVICES ELECTRICAL-MECHANICAL-WATER AND WASTEWATER DESIGN	BRIDGE No. POST MILE	MAGANA-ORTEGA MS GAS DRYER DETAILS	SHEET M-4
		DETAILS BY <i>Rudy Sarte</i> CHECKED <i>Mark Hedglin</i>		UNIT 3580 PROJECT NUMBER & PHASE 08000004541	DISREGARD PRINTS BEARING EARLIER REVISION DATES		REVISION DATES (PRELIMINARY STAGE ONLY) 05-08-10 06-02-10 06-30-10 07-28-10 08-25-10 09-22-10 11-08-10 12-08-10 3-15-12 12-4-12
		QUANTITIES BY <i>Mark Hedglin</i> CHECKED <i>Tom Hatam</i>	ORIGINAL SCALE IN INCHES FOR REDUCED PLANS	0 1 2 3	EA 08-OM0204		

USERNAME => s121614 DATE PLOTTED => 16-JAN-2013 TIME PLOTTED => 05:36


DIST	COUNTY	LOCATION CODE	POST MILES TOTAL PROJECT	SHEET No.	TOTAL SHEETS
08	SBd	5712		12	22


 REGISTERED ENGINEER-MECHANICAL 5-7-12
 No. M32912
 Exp. 9-30-14
 MECH
 STATE OF CALIFORNIA


12-24-12
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 Reviewed by: 
 FRANCIS SOLICH
 Date: 4/30/12

NOTE:
 Fuel Dispenser shall be constructed specifically to dispense CNG fuel. All internal components and seals shall be compatible with CNG.

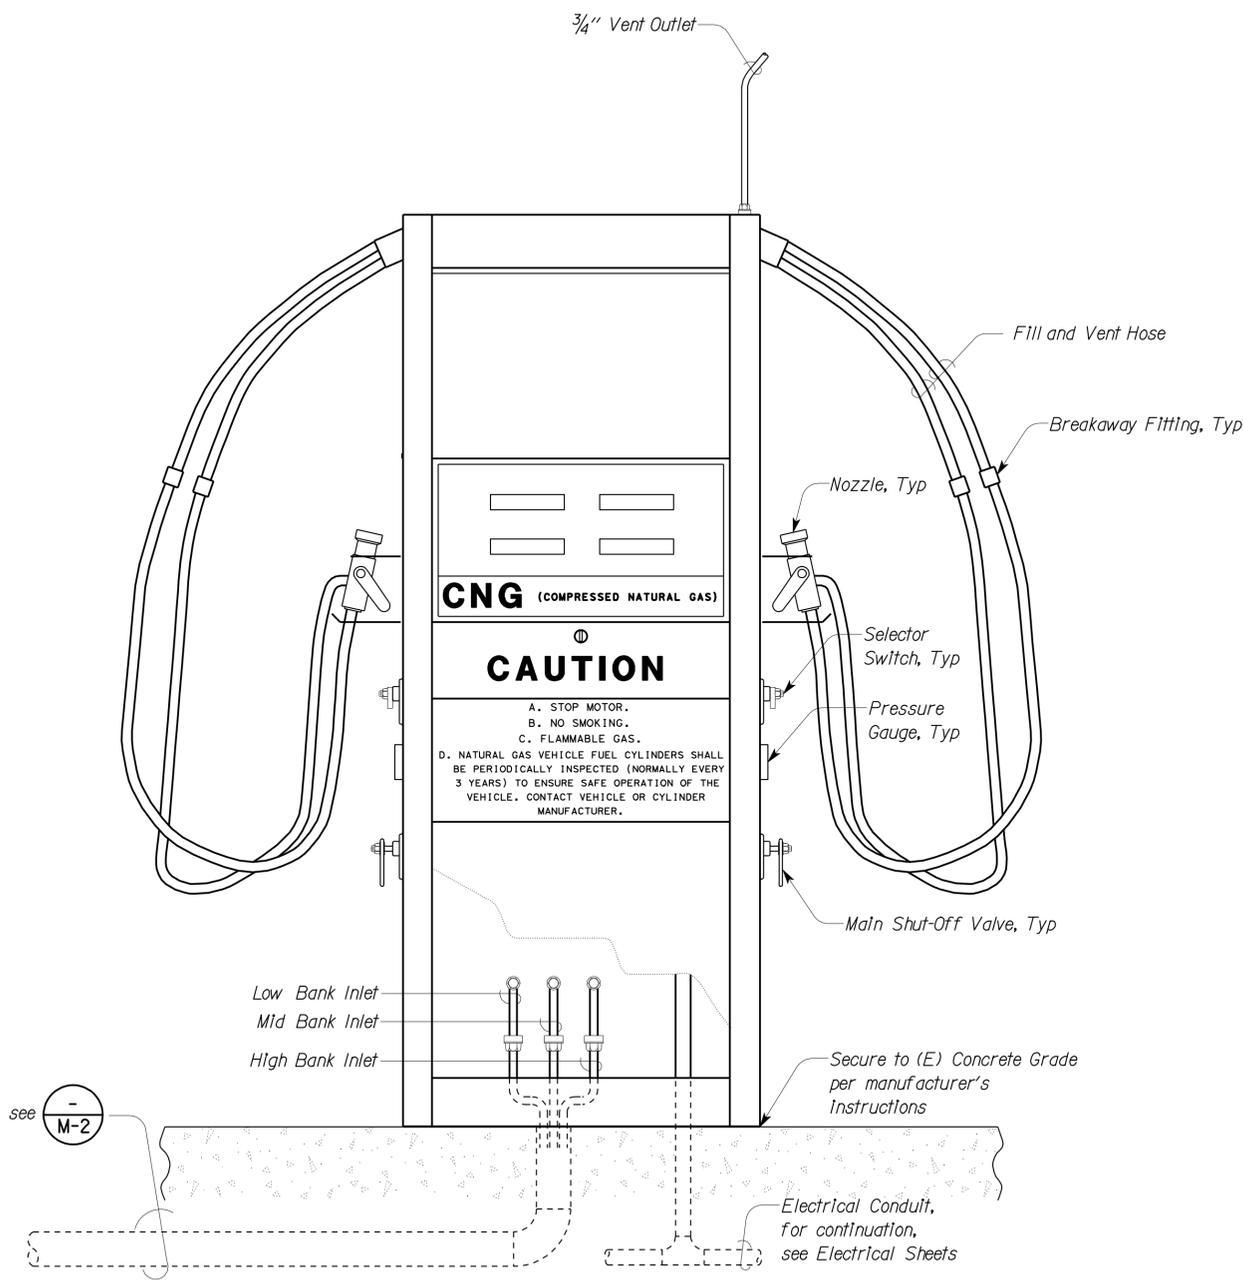

1 CNG QUICK FILL FUEL DISPENSER
 NO SCALE

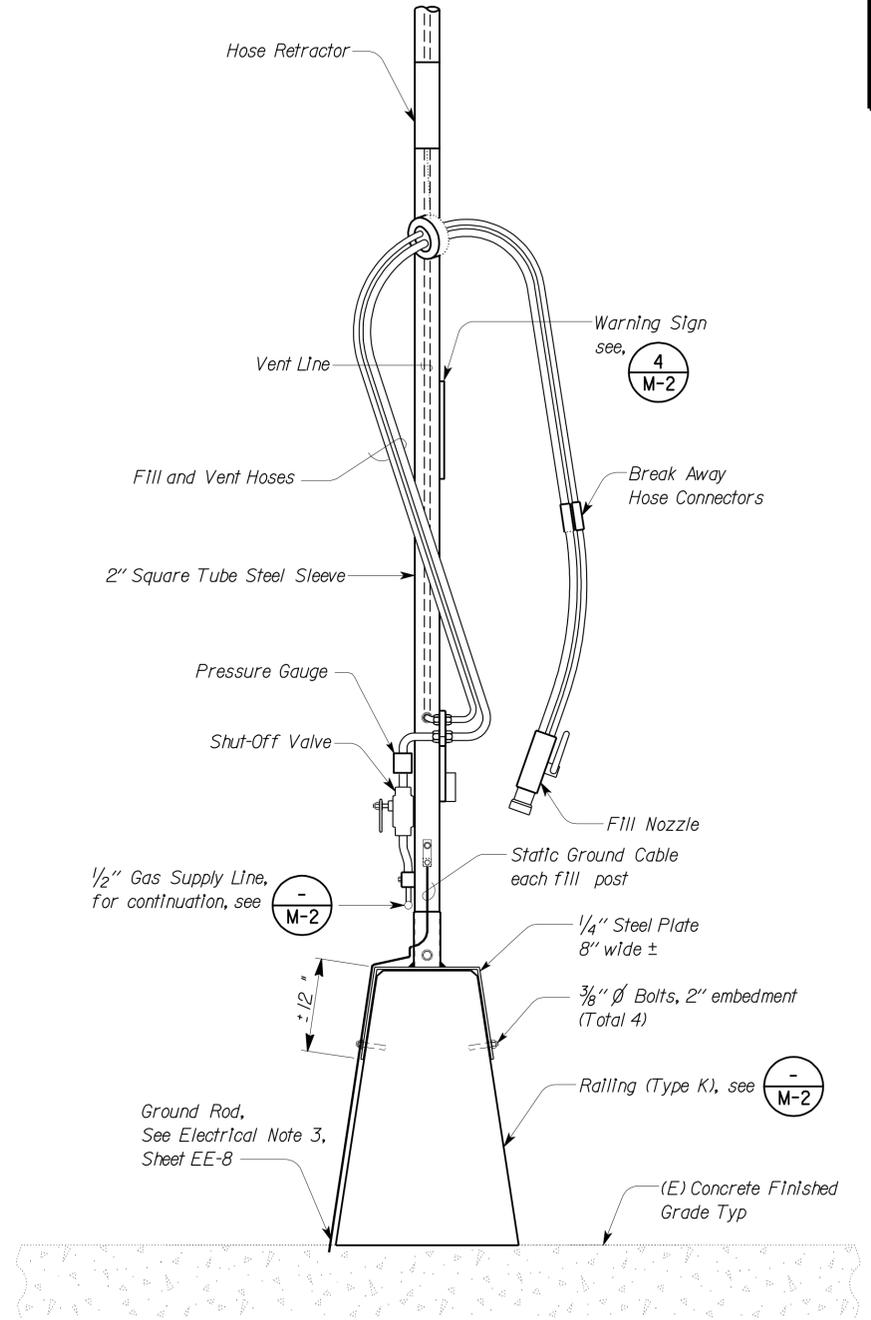

2 CNG TIME FILL FUEL DISPENSER
 NO SCALE

THIS DRAWING ACCURATE FOR MECHANICAL WORK ONLY

DESIGN BY <i>Mark Hedglin</i> CHECKED <i>Tom Hatam</i> DETAILS BY <i>Rudy Sarte</i> CHECKED <i>Mark Hedglin</i> QUANTITIES BY <i>Mark Hedglin</i> CHECKED <i>Tom Hatam</i>	STATE OF CALIFORNIA DEPARTMENT OF TRANSPORTATION	DIVISION OF ENGINEERING SERVICES ELECTRICAL-MECHANICAL-WATER AND WASTEWATER DESIGN	BRIDGE No.	MAGANA-ORTEGA MS MECHANICAL DETAILS NO. 1	SHEET	
			POST MILE		M-5	
DS OSD 2139A (4/89) FILE NO.:	FILE => m_5.dgn DATE PLOTTED => 16-JAN-2013	ORIGINAL SCALE IN INCHES FOR REDUCED PLANS	UNIT PROJECT NUMBER & PHASE 3580 08000004541	DISREGARD PRINTS BEARING EARLIER REVISION DATES	REVISION DATES (PRELIMINARY STAGE ONLY) 05-08-10 06-02-10 06-30-10 07-28-10 08-25-10 09-22-10 11-08-10 12-08-10 3-6-12 12-4-12	SHEET OF 12 OF 22

USERNAME => s121614 DATE PLOTTED => 16-JAN-2013 TIME PLOTTED => 05:36

DIST	COUNTY	LOCATION CODE	POST MILES TOTAL PROJECT	SHEET No.	TOTAL SHEETS
08	SBD	5712		13	22

Mark Hedglin 5-7-12
 REGISTERED ENGINEER-MECHANICAL
 No. M32912
 Exp. 9-30-14
 MECH
 STATE OF CALIFORNIA

PLANS APPROVAL DATE _____


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Fire Marshal Stamp


CALIFORNIA STATE FIRE MARSHAL APPROVED

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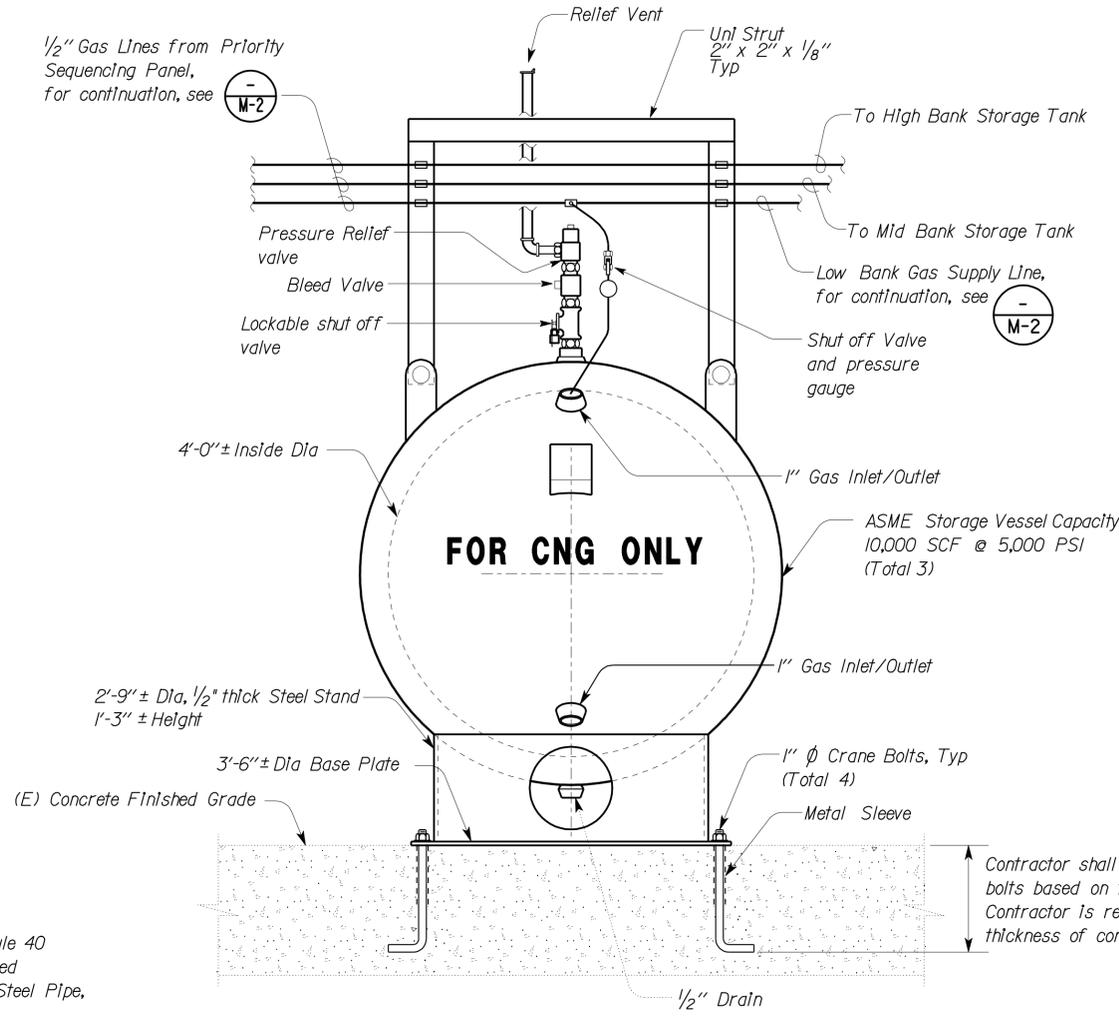
Reviewed by: Francis Solich
Date: 4/30/12




1 GUARD POST DETAIL
NO SCALE

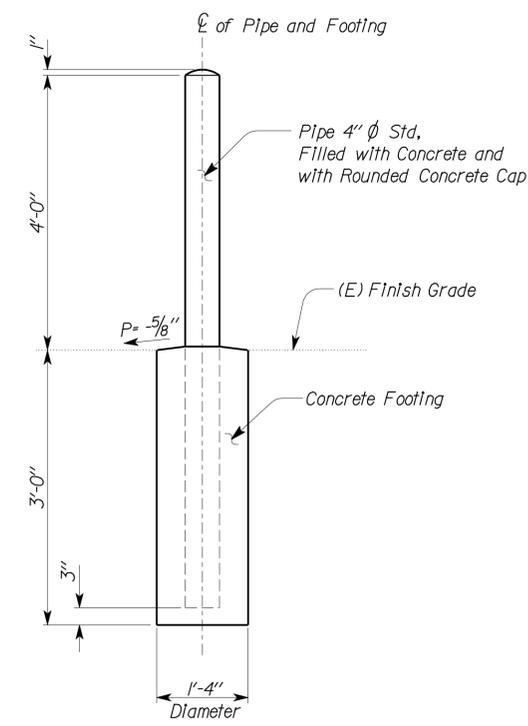

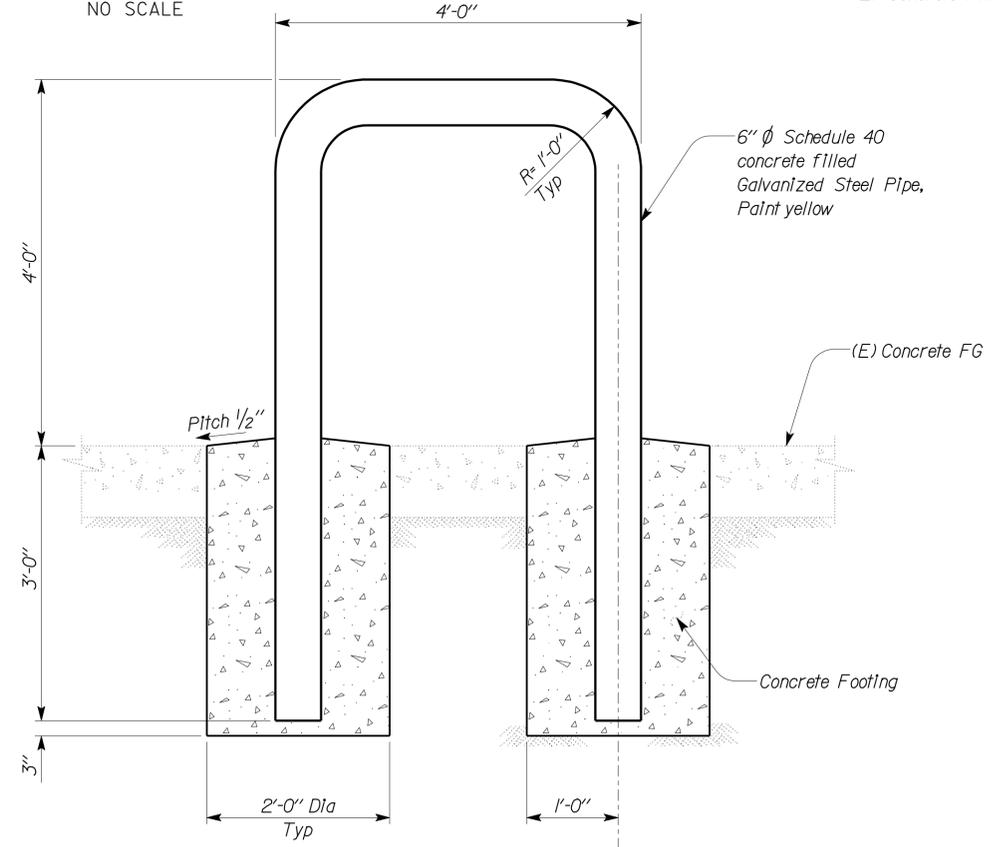
3 GUARD POST
NO SCALE



2 CNG STORAGE VESSEL
NO SCALE

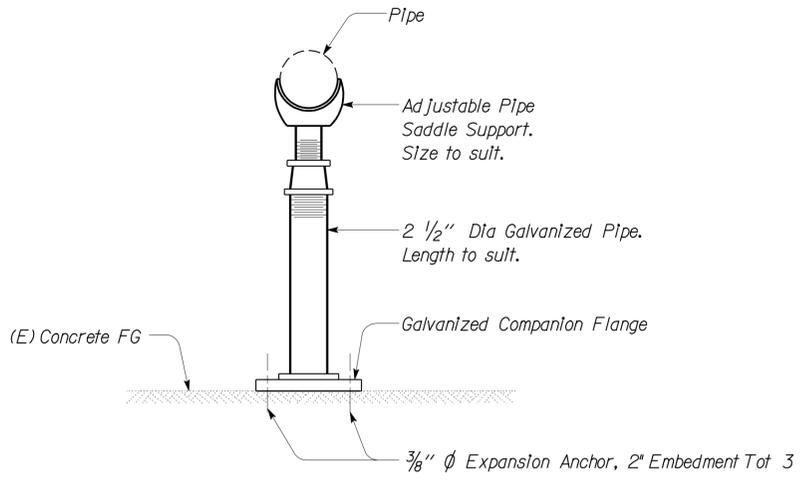

4 PIPE SUPPORT DETAIL
NO SCALE

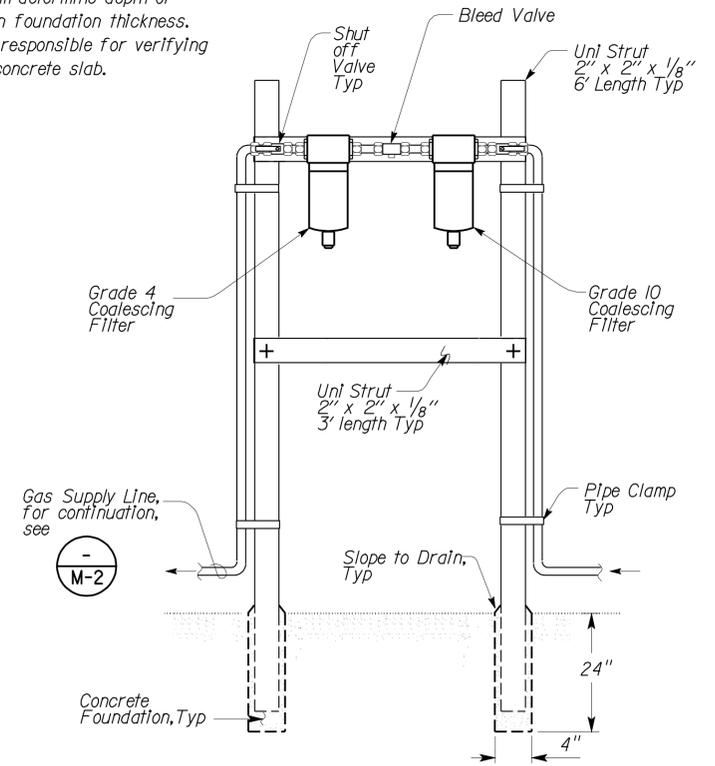


5 COALESCING FILTER RACK
NO SCALE


THIS DRAWING ACCURATE FOR MECHANICAL WORK ONLY

DESIGN	BY Mark Hedglin	CHECKED Tom Hatam	STATE OF CALIFORNIA DEPARTMENT OF TRANSPORTATION	DIVISION OF ENGINEERING SERVICES ELECTRICAL-MECHANICAL-WATER AND WASTEWATER DESIGN	BRIDGE No.	MAGANA-ORTEGA MS MECHANICAL DETAILS NO. 2	SHEET
DETAILS	BY Rudy Sarte	CHECKED Mark Hedglin			POST MILE		M-6
QUANTITIES	BY Mark Hedglin	CHECKED Tom Hatam					

DS OSD 2139A (4/89) FILE => m_6.dgn ORIGINAL SCALE IN INCHES FOR REDUCED PLANS 0 1 2 3
 DATE PLOTTED => 16-JAN-2013 TIME PLOTTED => 05:36 UNIT PROJECT NUMBER & PHASE 3580 08000004541
 DISREGARD PRINTS BEARING EARLIER REVISION DATES REVISION DATES (PRELIMINARY STAGE ONLY) 05-08-10 06-02-10 06-30-10 07-28-10 08-25-10 09-22-10 11-08-10 12-08-10 3-5-12 12-4-12 SHEET OF

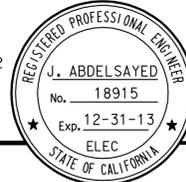DIST	COUNTY	LOCATION CODE	POST MILES TOTAL PROJECT	SHEET No.	TOTAL SHEETS
08	SBd	5712		15	22
 REGISTERED ELECTRICAL ENGINEER			06-04-12 DATE		
12-24-12 PLANS APPROVAL DATE					
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 Approval date: 4/30/12

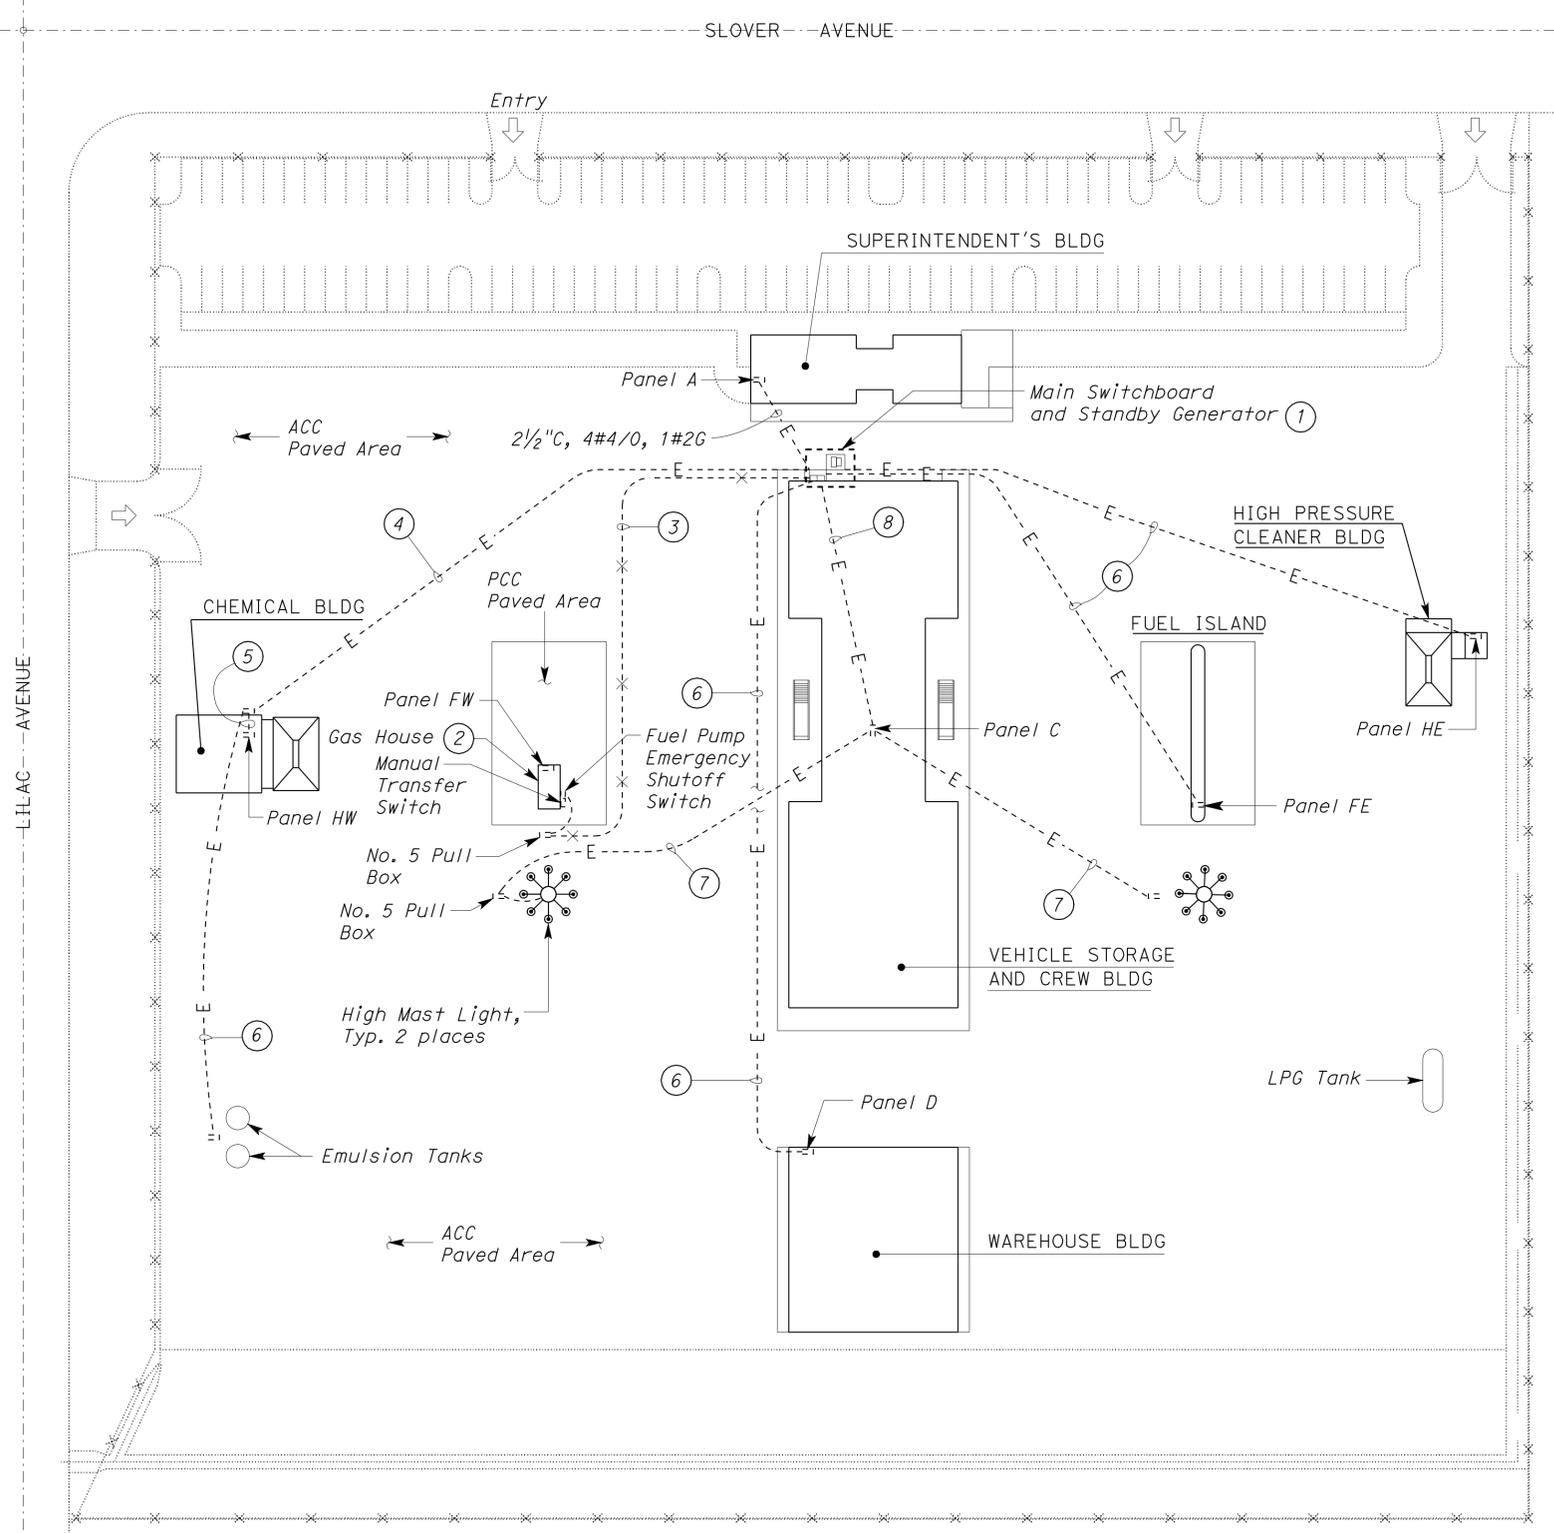

- Notes:
- ① For enlarged plan view, see sheet EE-3.
 - ② For enlarged plan view, see sheet EE-5.
 - ③ 1/2"C, 4#1, 1#6G to Manual Transfer Switch. Remove conductors, abandon underground conduit. For continuation, see sheet EE-3.
 - ④ (2) 1/2"C, 4#1, 1#6G.
 - ⑤ 1/2"C, 4#1.
 - ⑥ 1/2"C, 4#1, 1#6G.
 - ⑦ 1/2"C, 18#10, 1#10G.
 - ⑧ (2) 4"C, 4#600 MCM to Main Switchboard.

 **SITE PLAN**
 SCALE 1" = 40'-0"

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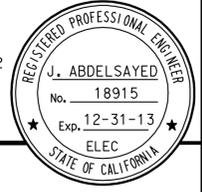
DESIGN SUPERVISOR <i>J. Schreff</i>	DESIGN	BY Joseph Abdelsayed	CHECKED J.S. Sandhu	STATE OF CALIFORNIA DEPARTMENT OF TRANSPORTATION	DIVISION OF ENGINEERING SERVICES ELECTRICAL-MECHANICAL-WATER AND WASTEWATER DESIGN	BRIDGE No.	MAGANA-ORTEGA MS	SHEET EE-1
	DESIGN ENGINEER <i>Jasvinder K. Sandhu</i>	DETAILS	BY Ed D. Tapalla 8/10			CHECKED Joseph Abdelsayed		
		QUANTITIES	BY Joseph Abdelsayed	CHECKED J.S. Sandhu			REVISION DATES (PRELIMINARY STAGE ONLY)	SHEET OF
DOES SD Imperial Rev. 9/02		ORIGINAL SCALE IN INCHES FOR REDUCED PLANS			0 1 2 3	UNIT PROJECT NUMBER & PHASE	3596 08000004541	DISREGARD PRINTS BEARING EARLIER REVISION DATES
					EA 08-0M0204	4/5/10 12/15/10 05/01/12 6/7/12 12/4/12		ee_01.dgn

DIST	COUNTY	LOCATION CODE	POST MILES TOTAL PROJECT	SHEET No.	TOTAL SHEETS
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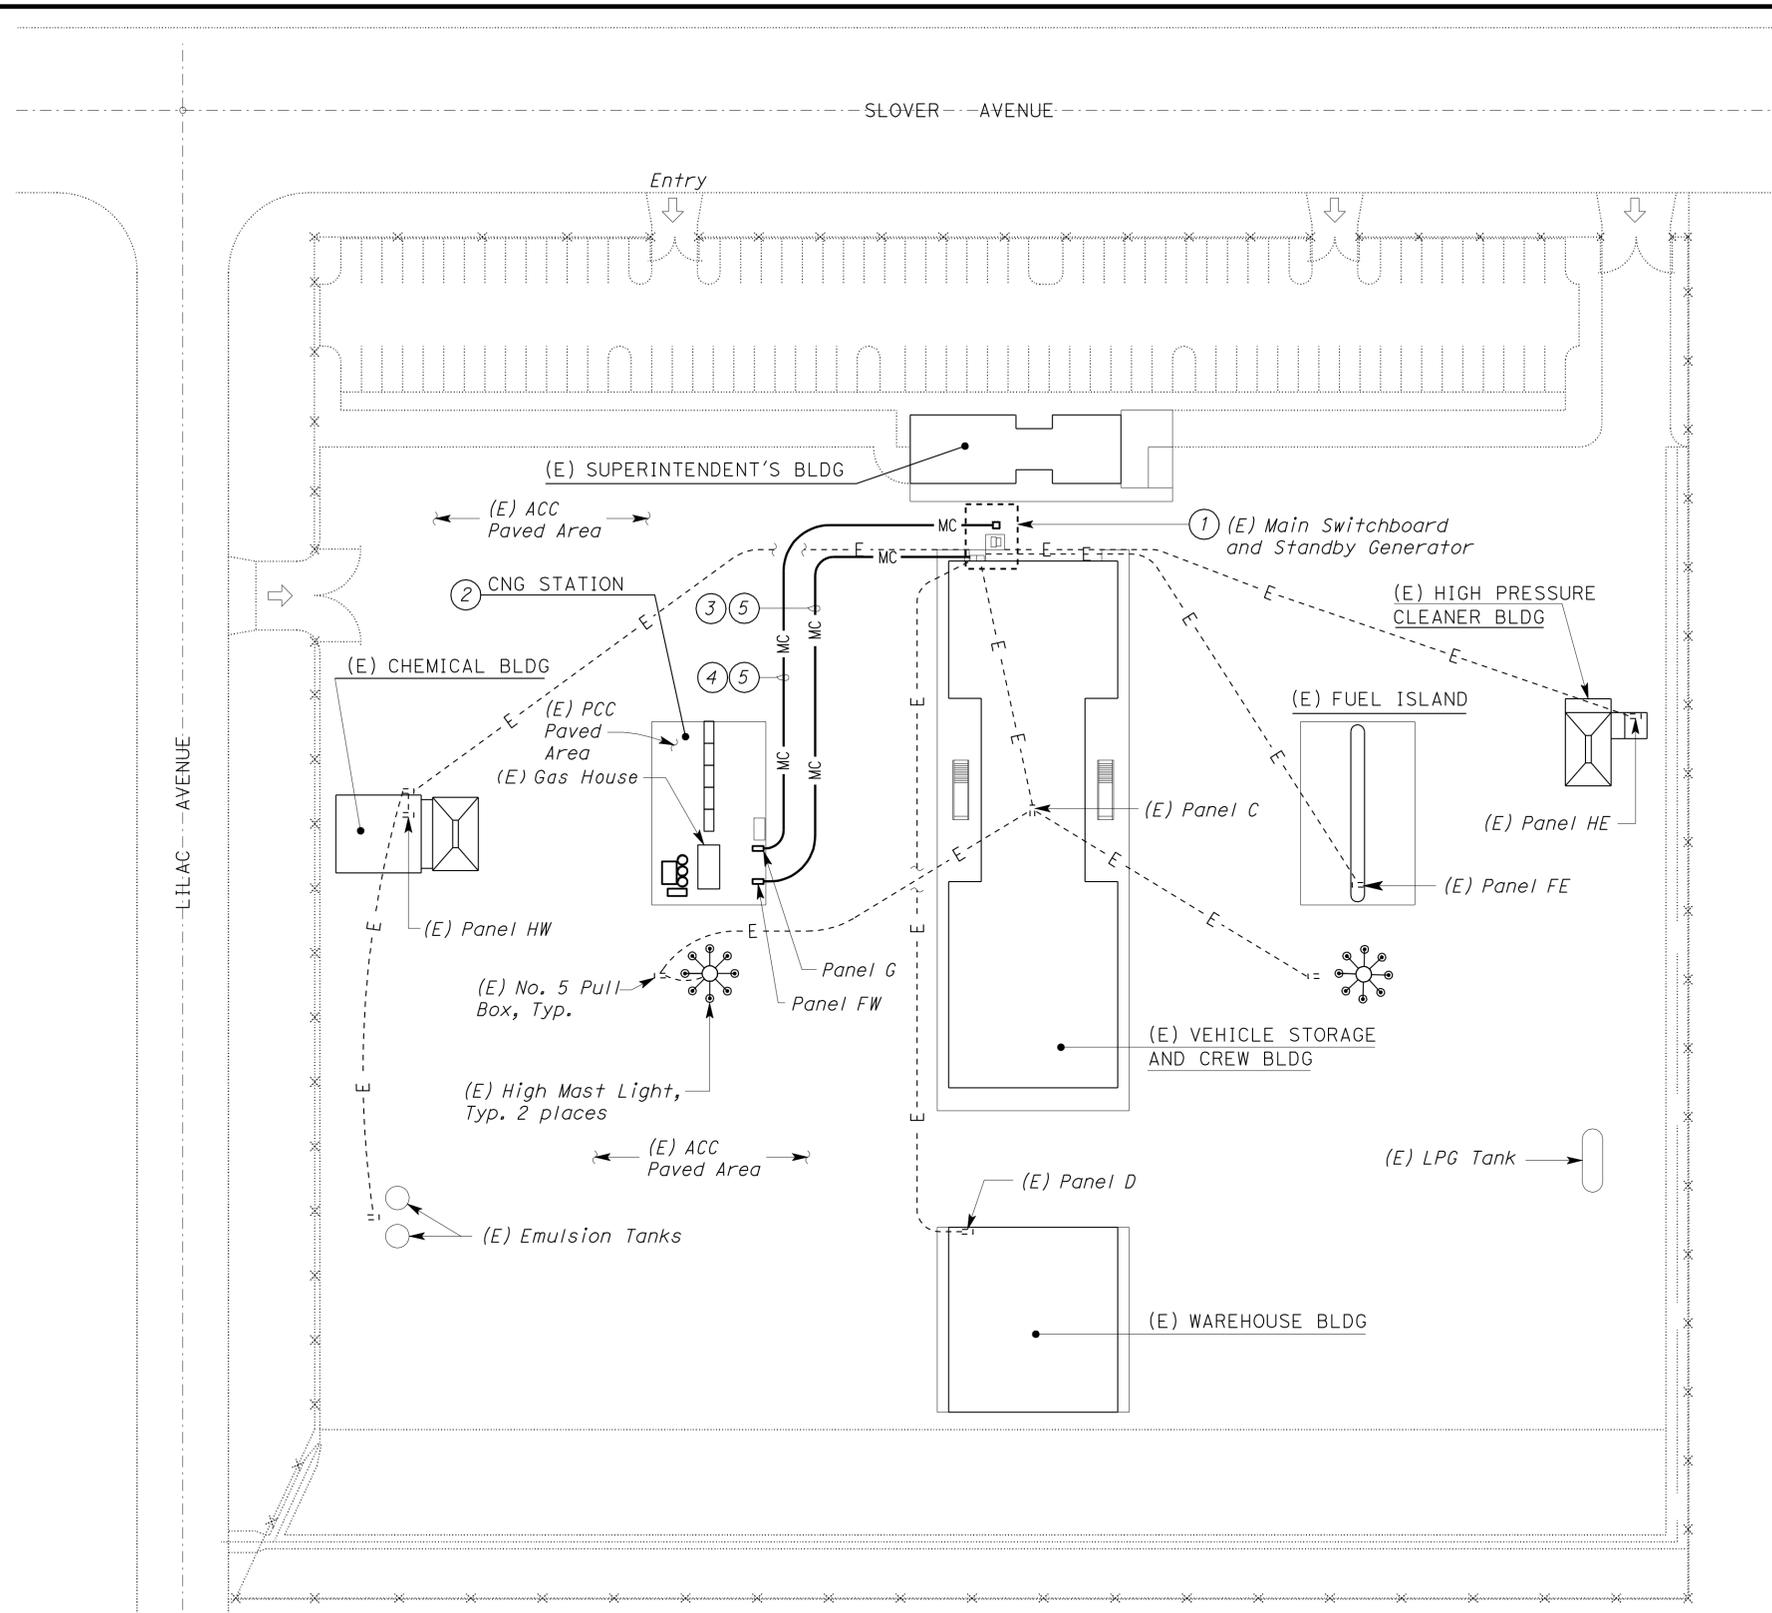
Joe Abdelsayed
 REGISTERED ELECTRICAL ENGINEER
 DATE 06-04-12

12-24-12
 PLANS APPROVAL DATE

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 Reviewed by: FRANCIS SOLICH
 Approval date: 4/30/12



General Note:

A. Not all existing underground conduits and pipes are shown. In addition, location of the entire existing conduit and conductor system is approximate only. Therefore, the contractor shall verify location of all existing underground conduits and pipes prior to jacking conduits. Verifying location of existing conduits and pipes shall be paid as part of building lump sum.

Notes:

- ① For enlarged plan view see sheet EE-4.
- ② For enlarged plan view of CNG Station and adjacent High Mast Light, see sheet EE-6.
- ③ 2" C, 4#1, 1#6G to Main Switchboard. For continuation, see sheet EE-4.
- ④ 3" C, 3#300 MCM, 1#2G to CNG Transformer. For continuation, see sheet EE-4.
- ⑤ Jack conduit underneath existing paved surfaces.



SITE PLAN
SCALE 1" = 40'-0"

THIS DRAWING ACCURATE FOR ELECTRICAL WORK ONLY

DESIGN BY <i>Joseph Abdelsayed</i>	CHECKED <i>J.S. Sandhu</i>	STATE OF CALIFORNIA DEPARTMENT OF TRANSPORTATION	DIVISION OF ENGINEERING SERVICES ELECTRICAL-MECHANICAL-WATER AND WASTEWATER DESIGN	BRIDGE No.	MAGANA-ORTEGA MS	SHEET EE-2					
				POST MILE			MODIFIED SITE PLAN				
DETAILS BY <i>Ed D. Tapalla 8/10</i>	CHECKED <i>Joseph Abdelsayed</i>	ORIGINAL SCALE IN INCHES FOR REDUCED PLANS 0 1 2 3	UNIT PROJECT NUMBER & PHASE 3596 08000004541	REVISION DATES (PRELIMINARY STAGE ONLY)			SHEET OF				
QUANTITIES BY <i>Joseph Abdelsayed</i>	CHECKED <i>J.S. Sandhu</i>			<table border="1"> <tr> <td>12/15/10</td> <td>05/07/12</td> <td>07/11/12</td> <td>12/11/12</td> <td></td> <td></td> <td></td> </tr> </table>				12/15/10	05/07/12	07/11/12	12/11/12
12/15/10	05/07/12	07/11/12	12/11/12								

DOES SD Imperial Rev. 9/02

EA 08-0M0204


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DIST	COUNTY	LOCATION CODE	POST MILES TOTAL PROJECT	SHEET No.	TOTAL SHEETS
08	SBD	5712		17	22

Joe Abdelsayed
 REGISTERED ELECTRICAL ENGINEER
 DATE 06-04-12
 No. 18915
 Exp. 12-31-13
 ELEC
 STATE OF CALIFORNIA


12-24-12
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 Reviewed by: *Francis Solich*
 FRANCIS SOLICH
 Approval date: 4/30/12



ENLARGED PLAN
NO SCALE

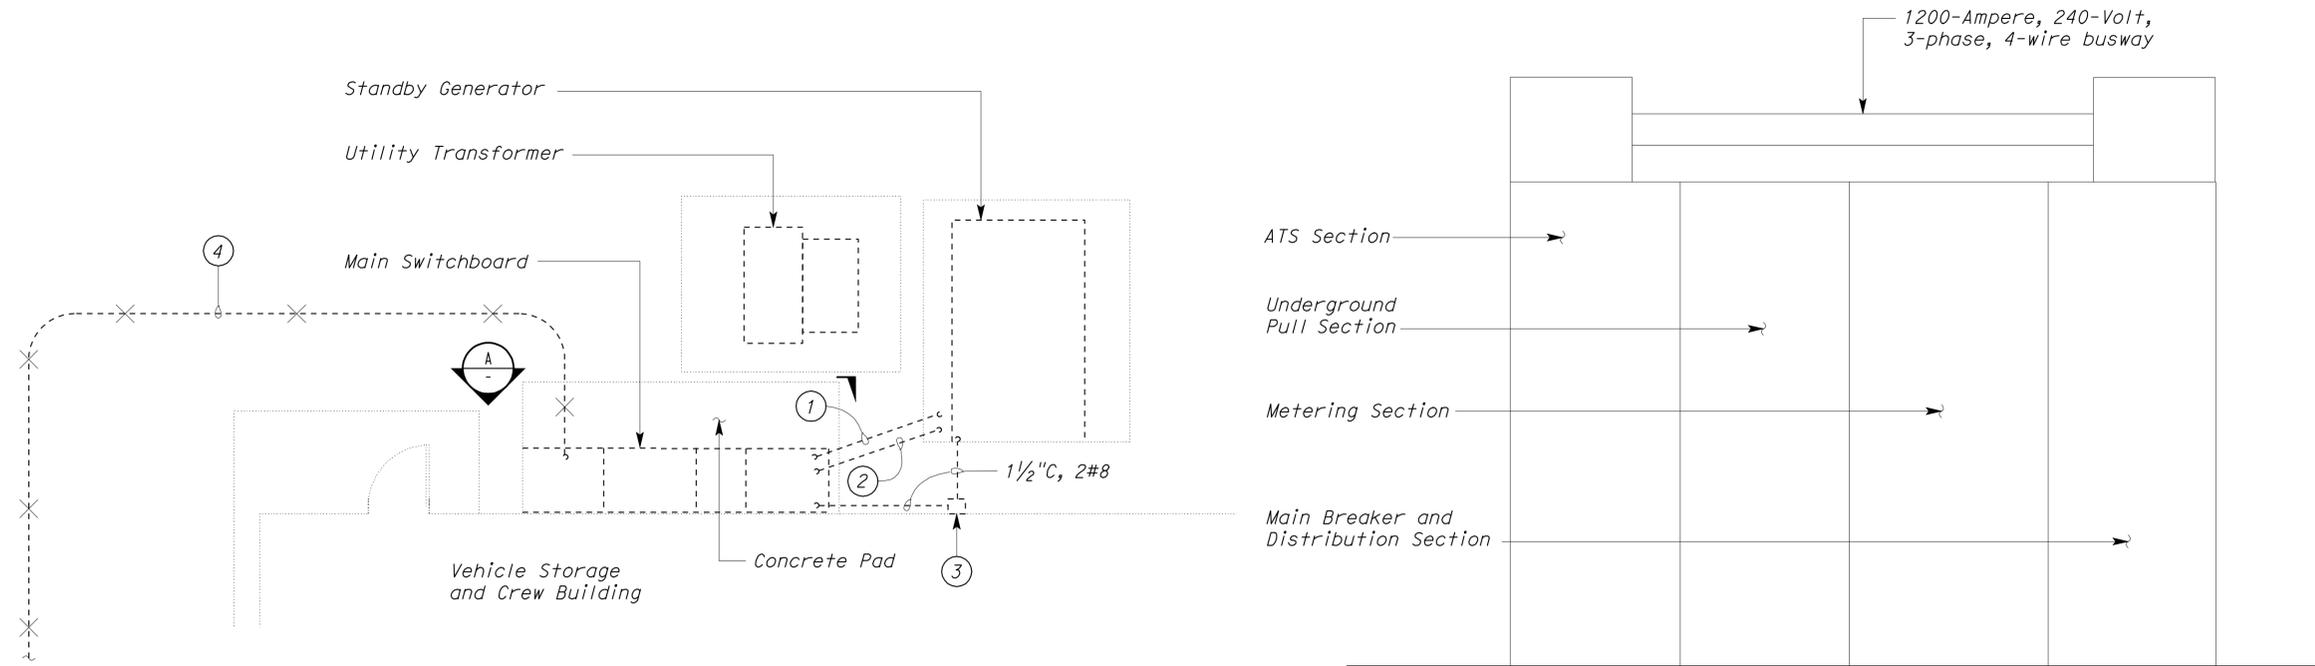A ELEVATION
NO SCALE

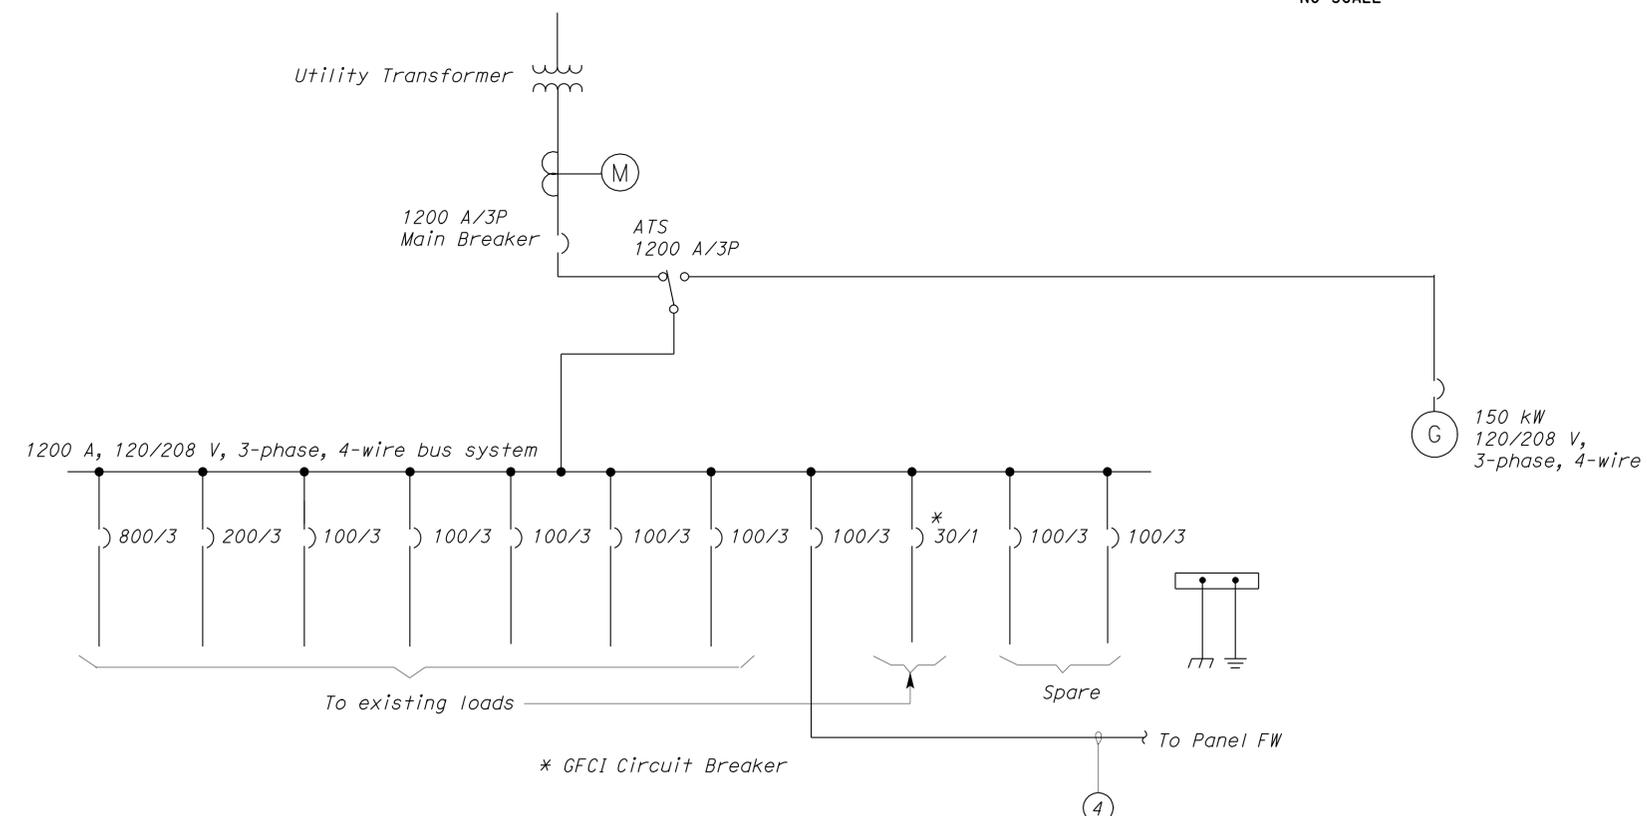

EXISTING SINGLE LINE DIAGRAM
NO SCALE

- Notes:
- ① (2) 4" C, 4#350 MCM.
 - ② 1/2" C, Control conductors.
 - ③ Engine preheater and battery charger disconnect.
 - ④ 1/2" C, 4#1, 1#6G to No. 5 Pull Box for feeding Panel FW. Remove conductors and abandon underground conduit. For continuation, see sheet EE-1.

THIS DRAWING ACCURATE FOR ELECTRICAL WORK ONLY


DESIGN BY <i>Joseph Abdelsayed</i>	CHECKED <i>J.S. Sandhu</i>	STATE OF CALIFORNIA DEPARTMENT OF TRANSPORTATION	DIVISION OF ENGINEERING SERVICES ELECTRICAL-MECHANICAL-WATER AND WASTEWATER DESIGN	BRIDGE No.	MAGANA-ORTEGA MS	SHEET EE-3					
				POST MILE			EXISTING MAIN SWITCHBOARD				
DETAILS BY <i>Joseph Abdelsayed</i>	CHECKED <i>J.S. Sandhu</i>	ORIGINAL SCALE IN INCHES FOR REDUCED PLANS 0 1 2 3	UNIT PROJECT NUMBER & PHASE 3596 0800004541	REVISION DATES (PRELIMINARY STAGE ONLY)			SHEET OF				
QUANTITIES BY <i>Joseph Abdelsayed</i>	CHECKED <i>J.S. Sandhu</i>			<table border="1"> <tr> <td>12/15/10</td> <td>05/07/12</td> <td>6/4/12</td> <td>12/4/12</td> <td></td> <td></td> <td></td> </tr> </table>				12/15/10	05/07/12	6/4/12	12/4/12
12/15/10	05/07/12	6/4/12	12/4/12								

Dist	COUNTY	LOCATION CODE	POST MILES TOTAL PROJECT	SHEET No.	TOTAL SHEETS
08	SBd	5712		18	22


<i>Joe Abdelsayed</i>		06-04-12
REGISTERED ELECTRICAL ENGINEER	DATE	

12-24-12	
PLANS APPROVAL DATE	

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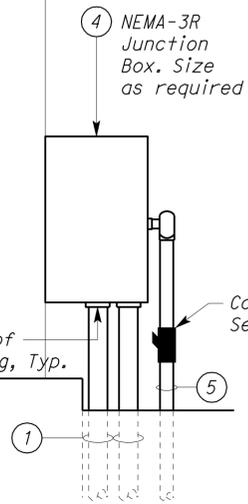

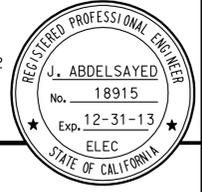
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 Reviewed by: FRANCIS SOLICH
 Approval date: 4/30/12

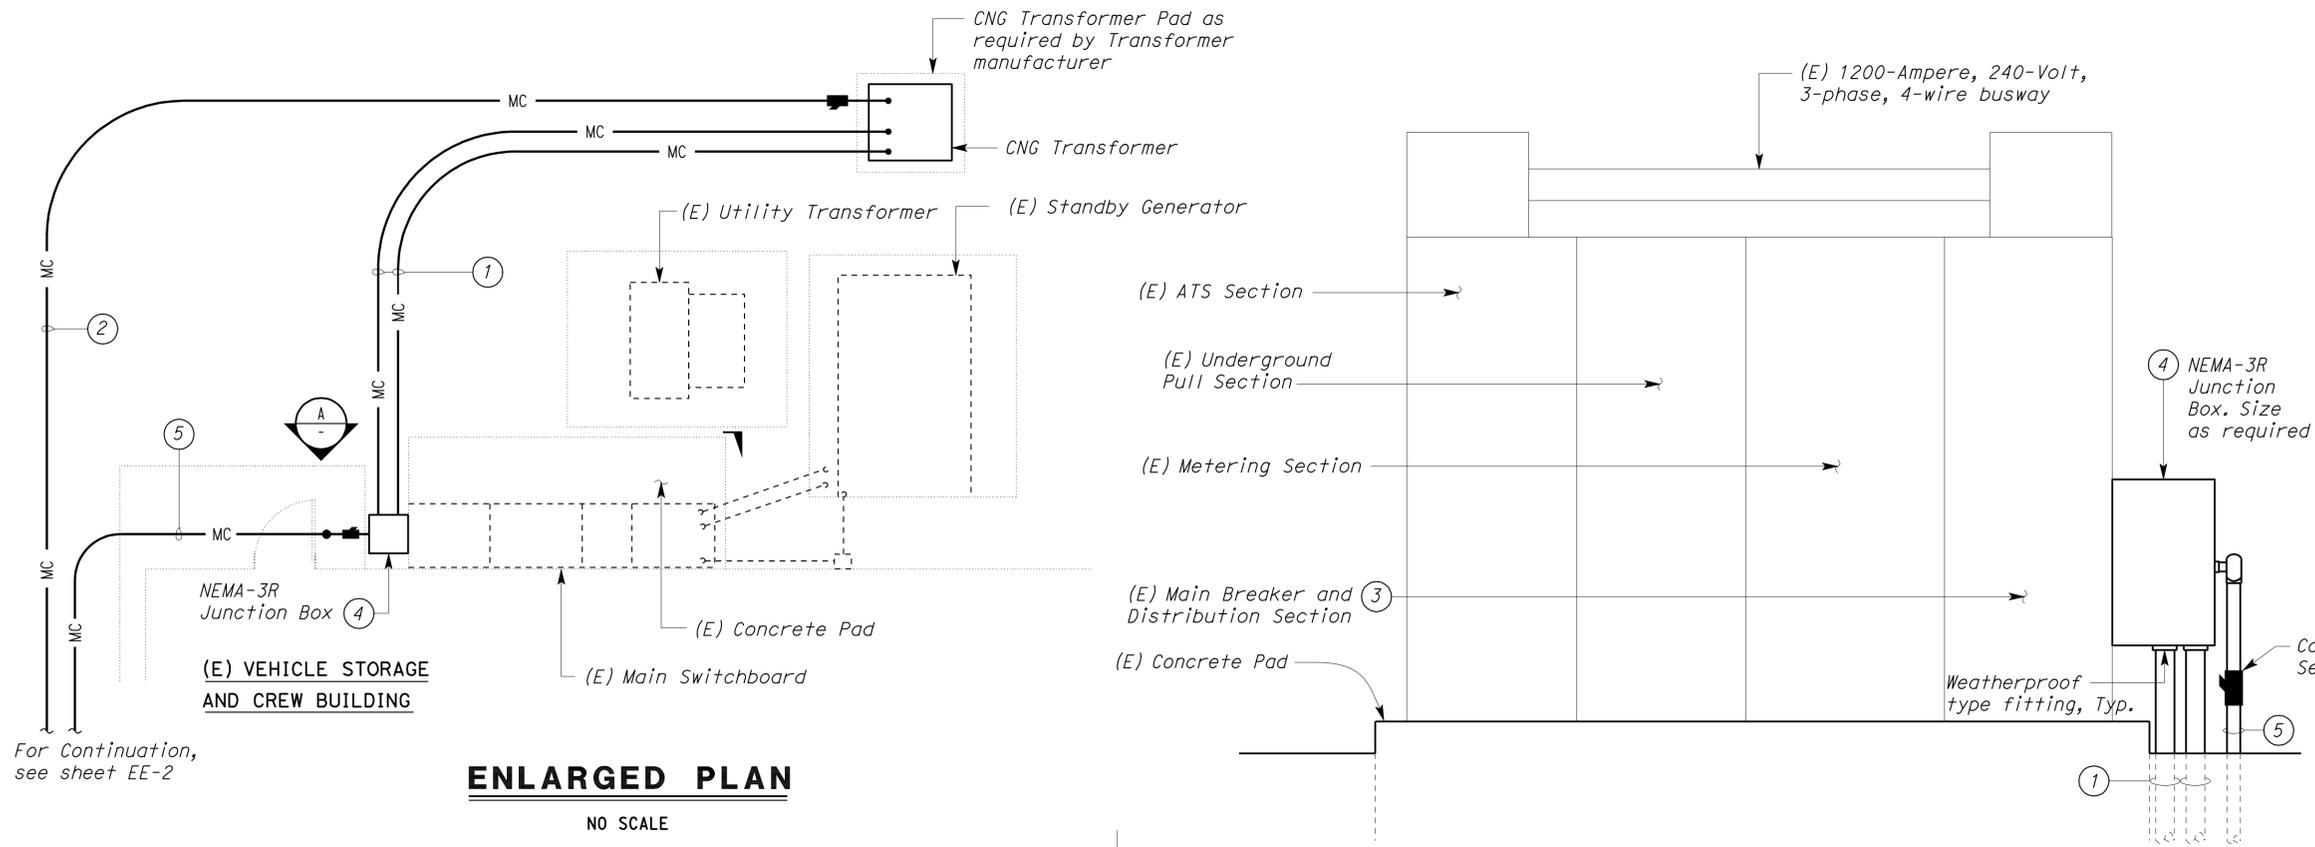

ENLARGED PLAN
NO SCALE


For Continuation, see sheet EE-2



A ELEVATION
NO SCALE

Notes:

- ① 3" C, 3#300 MCM, 1#2G.
- ② 3" C, 3#300 MCM, 1#2G to Panel G.
- ③ Existing Main Switchboard is type Square D, 1200-A, 120/208-V, 3-phase 4-wire switchboard, catalog number 2867 416-A0. Install 400 A/3P circuit breaker with power distribution type lugs inside the Main Breaker and Distribution Section of the Main Switchboard. Terminate 6#300 MCM ungrounded circuit conductors onto the load side of the 400 A/3P circuit breaker and rewire 3#1 ungrounded circuit conductors onto the load side of the existing 100 A/3P circuit breaker feeding Panel FW. Terminate grounded circuit conductor onto the neutral bus, and terminate both equipment grounding conductors onto the ground bus. Provide label for new 400 A/3P circuit breaker that reads, "PANEL G".
- ④ Mount NEMA-3R junction box onto existing Main Switchboard at a height as directed by the Engineer in the field. Punch hole through NEMA-3R Junction Box and through existing Main Switchboard and install three conduit nipples with bushings. Install (2) 3" C, 3#300, 1#2G and (1) 2" C, 4#1, 1#6G and wire.
- ⑤ 2" C, 4#1, 1#6G to Panel FW.

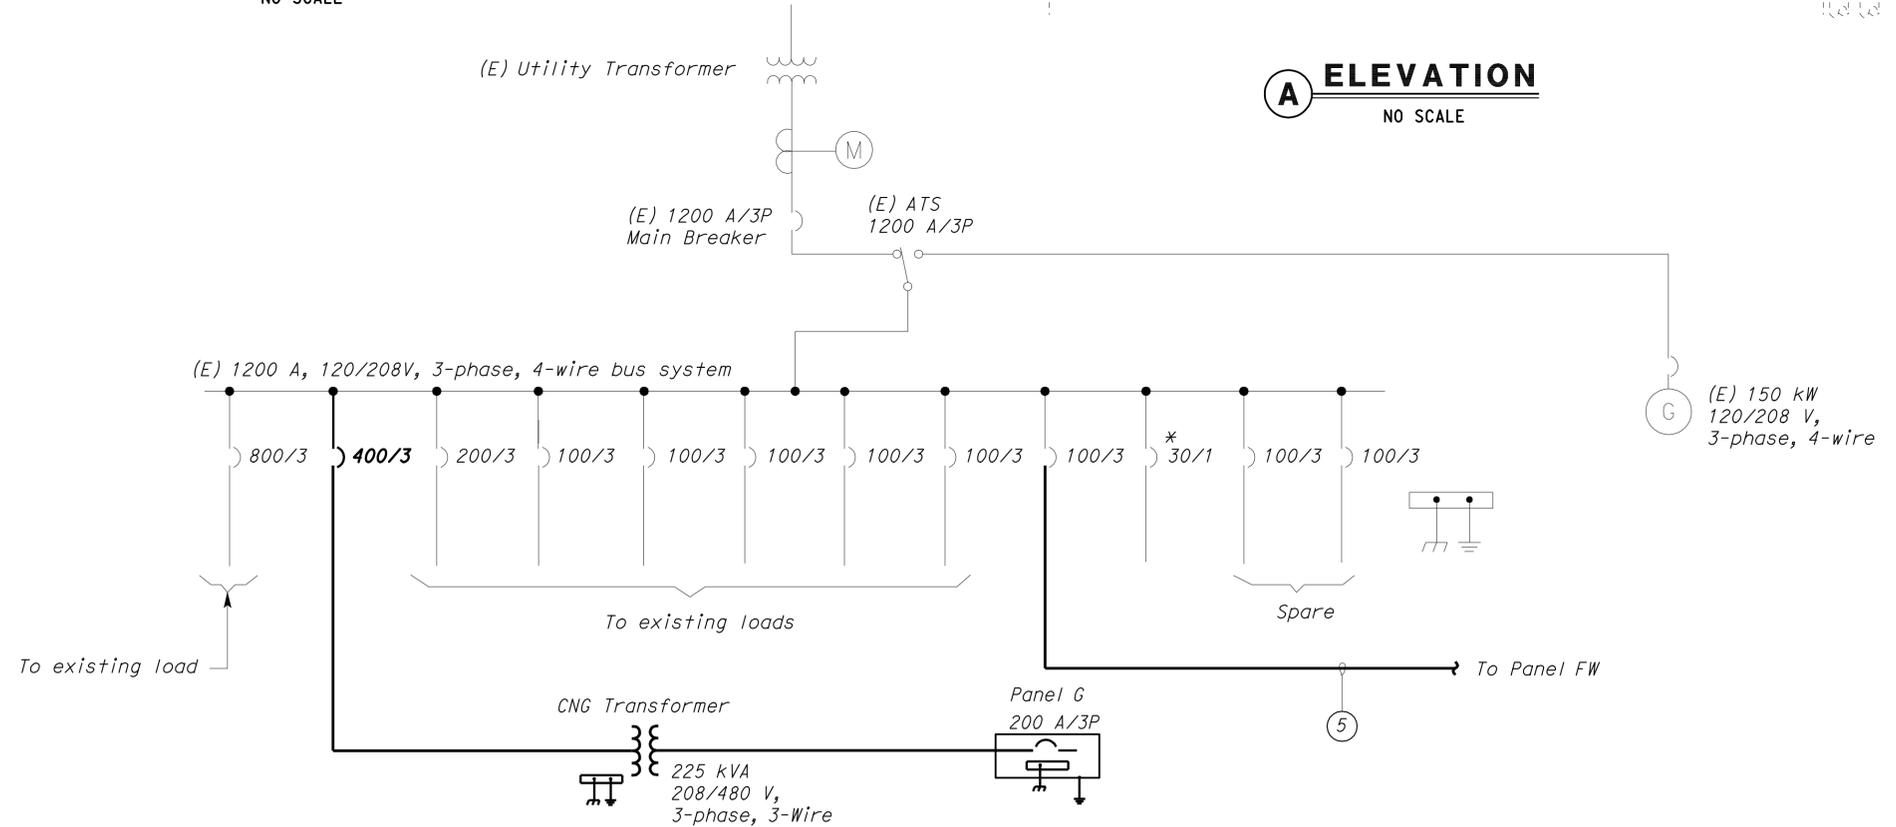

MODIFIED SINGLE LINE DIAGRAM
NO SCALE

* GFCI Circuit Breaker

THIS DRAWING ACCURATE FOR ELECTRICAL WORK ONLY


DESIGN BY <i>Joseph Abdelsayed</i> CHECKED <i>J.S. Sandhu</i>	STATE OF CALIFORNIA DEPARTMENT OF TRANSPORTATION	DIVISION OF ENGINEERING SERVICES ELECTRICAL-MECHANICAL-WATER AND WASTEWATER DESIGN	BRIDGE No.	MAGANA-ORTEGA MS	SHEET
			POST MILE		EE-4
			MODIFIED MAIN SWITCHBOARD		
DETAILS BY <i>Joseph Abdelsayed</i> CHECKED <i>J.S. Sandhu</i>	ORIGINAL SCALE IN INCHES FOR REDUCED PLANS	UNIT PROJECT NUMBER & PHASE 3596 08000004541	DISREGARD PRINTS BEARING EARLIER REVISION DATES	REVISION DATES (PRELIMINARY STAGE ONLY)	SHEET OF
QUANTITIES BY <i>Joseph Abdelsayed</i> CHECKED <i>J.S. Sandhu</i>	0 1 2 3	EA 08-0M0204	12/15/10 05/02/12 04/12 12/1/12		

Dist.	COUNTY	LOCATION CODE	POST MILES TOTAL PROJECT	SHEET No.	TOTAL SHEETS
08	SBd	5712		19	22


<i>Joe Abdelsayed</i> REGISTERED ELECTRICAL ENGINEER	06-04-12 DATE
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12-24-12 PLANS APPROVAL DATE


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 Approval of this plan does not authorize or approve any omission or deviation from applicable regulations. Final approval is subject to field inspection. One set of approved plans shall be available on the project site at all times.
 Reviewed by: *Francis Solich*
 FRANCIS SOLICH
 Approval date: 4/30/12

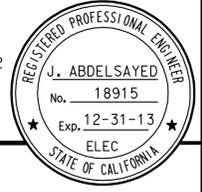

PLAN
 SCALE 1/2" = 1'-0"

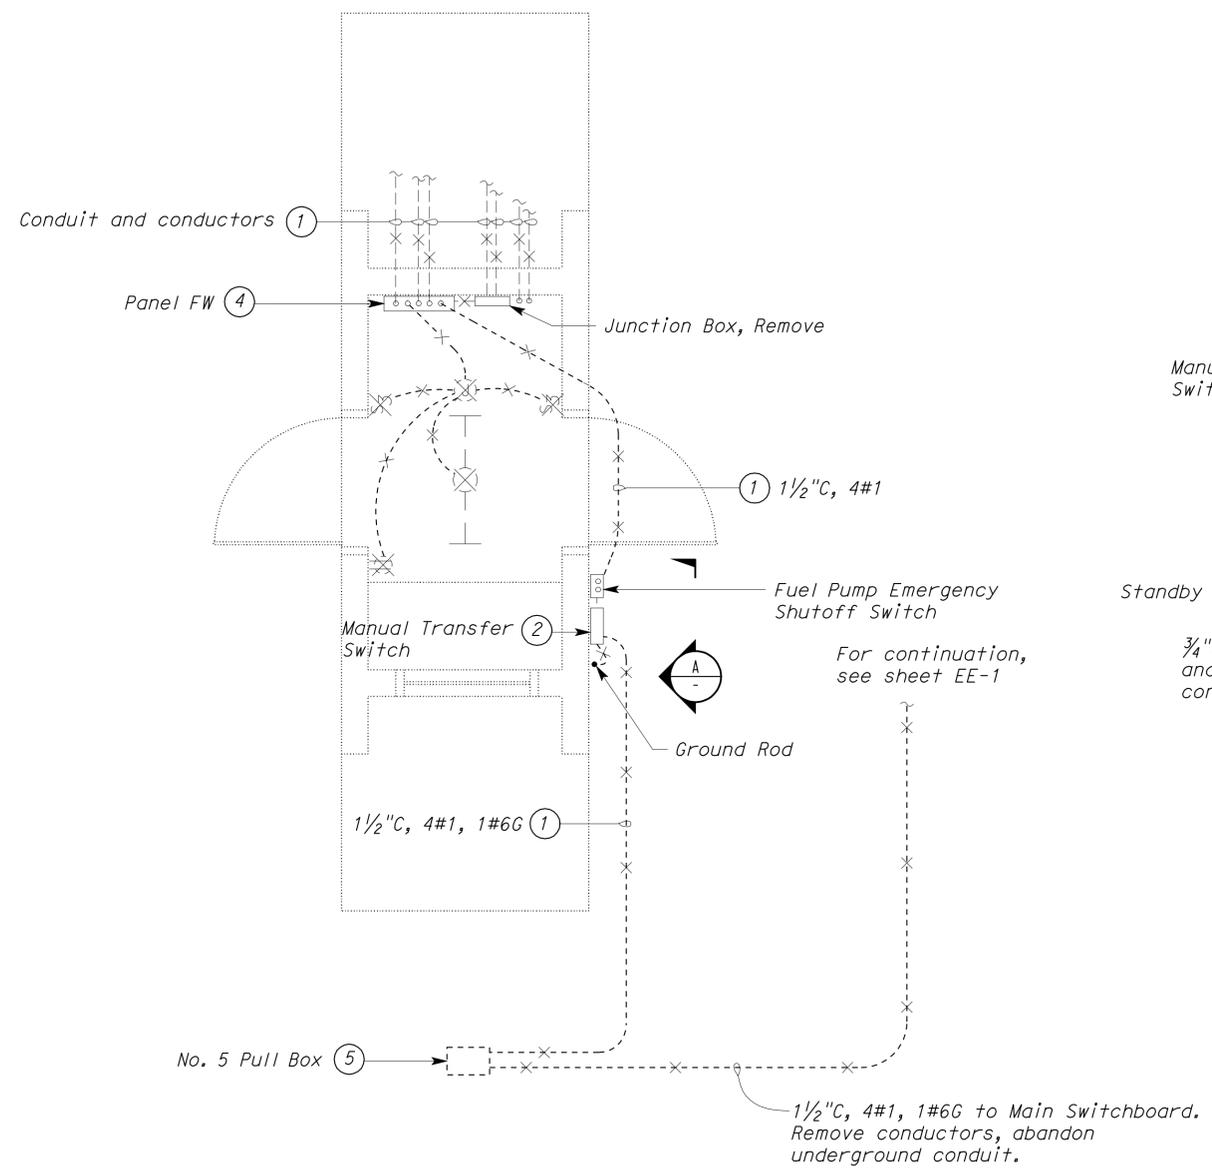

A ELEVATION
 NO SCALE

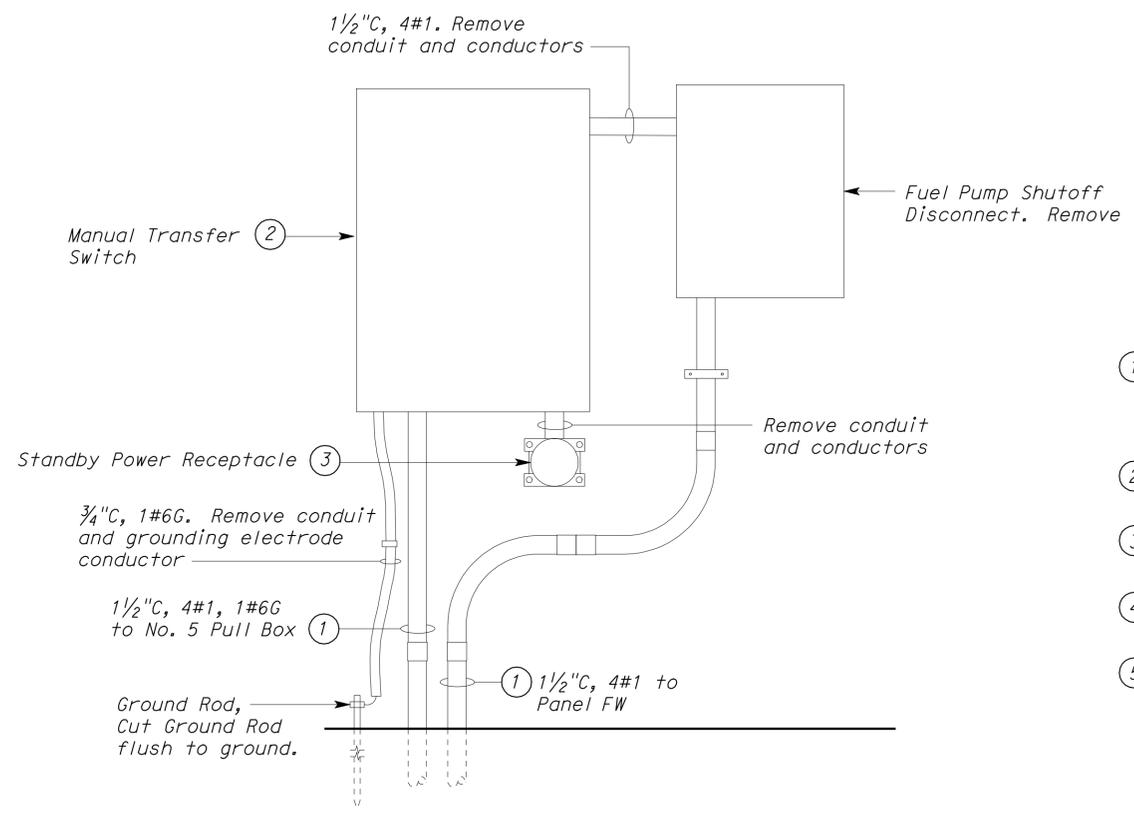
- Notes:**
- ① Remove conductors and abandon underground conduit. Cut exposed portion of conduit flush to ground and fill resulting hole with mortar.
 - ② Salvage Manual Transfer Switch and deliver to Caltrans maintenance personnel.
 - ③ Salvage Standby Power Receptacle and deliver to Caltrans maintenance personnel.
 - ④ Salvage Panel FW and deliver to Caltrans maintenance personnel.
 - ⑤ Remove pull box, and pave hole resulting from pull box removal as directed by the engineer.


THIS DRAWING ACCURATE FOR ELECTRICAL WORK ONLY

DESIGN BY <i>Joseph Abdelsayed</i> CHECKED <i>J.S. Sandhu</i>	STATE OF CALIFORNIA DEPARTMENT OF TRANSPORTATION	DIVISION OF ENGINEERING SERVICES ELECTRICAL-MECHANICAL-WATER AND WASTEWATER DESIGN	BRIDGE No.	MAGANA-ORTEGA MS	SHEET	
			POST MILE		EXISTING GAS HOUSE	EE-5
DETAILS BY <i>Dall Zhou</i> CHECKED <i>Joseph Abdelsayed</i>	ORIGINAL SCALE IN INCHES FOR REDUCED PLANS 0 1 2 3	UNIT PROJECT NUMBER & PHASE 3596 0800004541	REVISION DATES (PRELIMINARY STAGE ONLY)			SHEET OF
QUANTITIES BY <i>Joseph Abdelsayed</i> CHECKED <i>J.S. Sandhu</i>			12/15/10 05/07/12 6/4/12 12/4/12			OF


Dist.	COUNTY	LOCATION CODE	POST MILES TOTAL PROJECT	SHEET No.	TOTAL SHEETS
08	SbD	5712		20	22

 REGISTERED ELECTRICAL ENGINEER		DATE 06-04-12
12-24-12 PLANS APPROVAL DATE		
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For continuation, see sheet EE-2

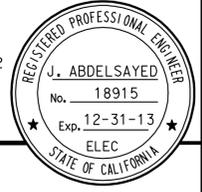

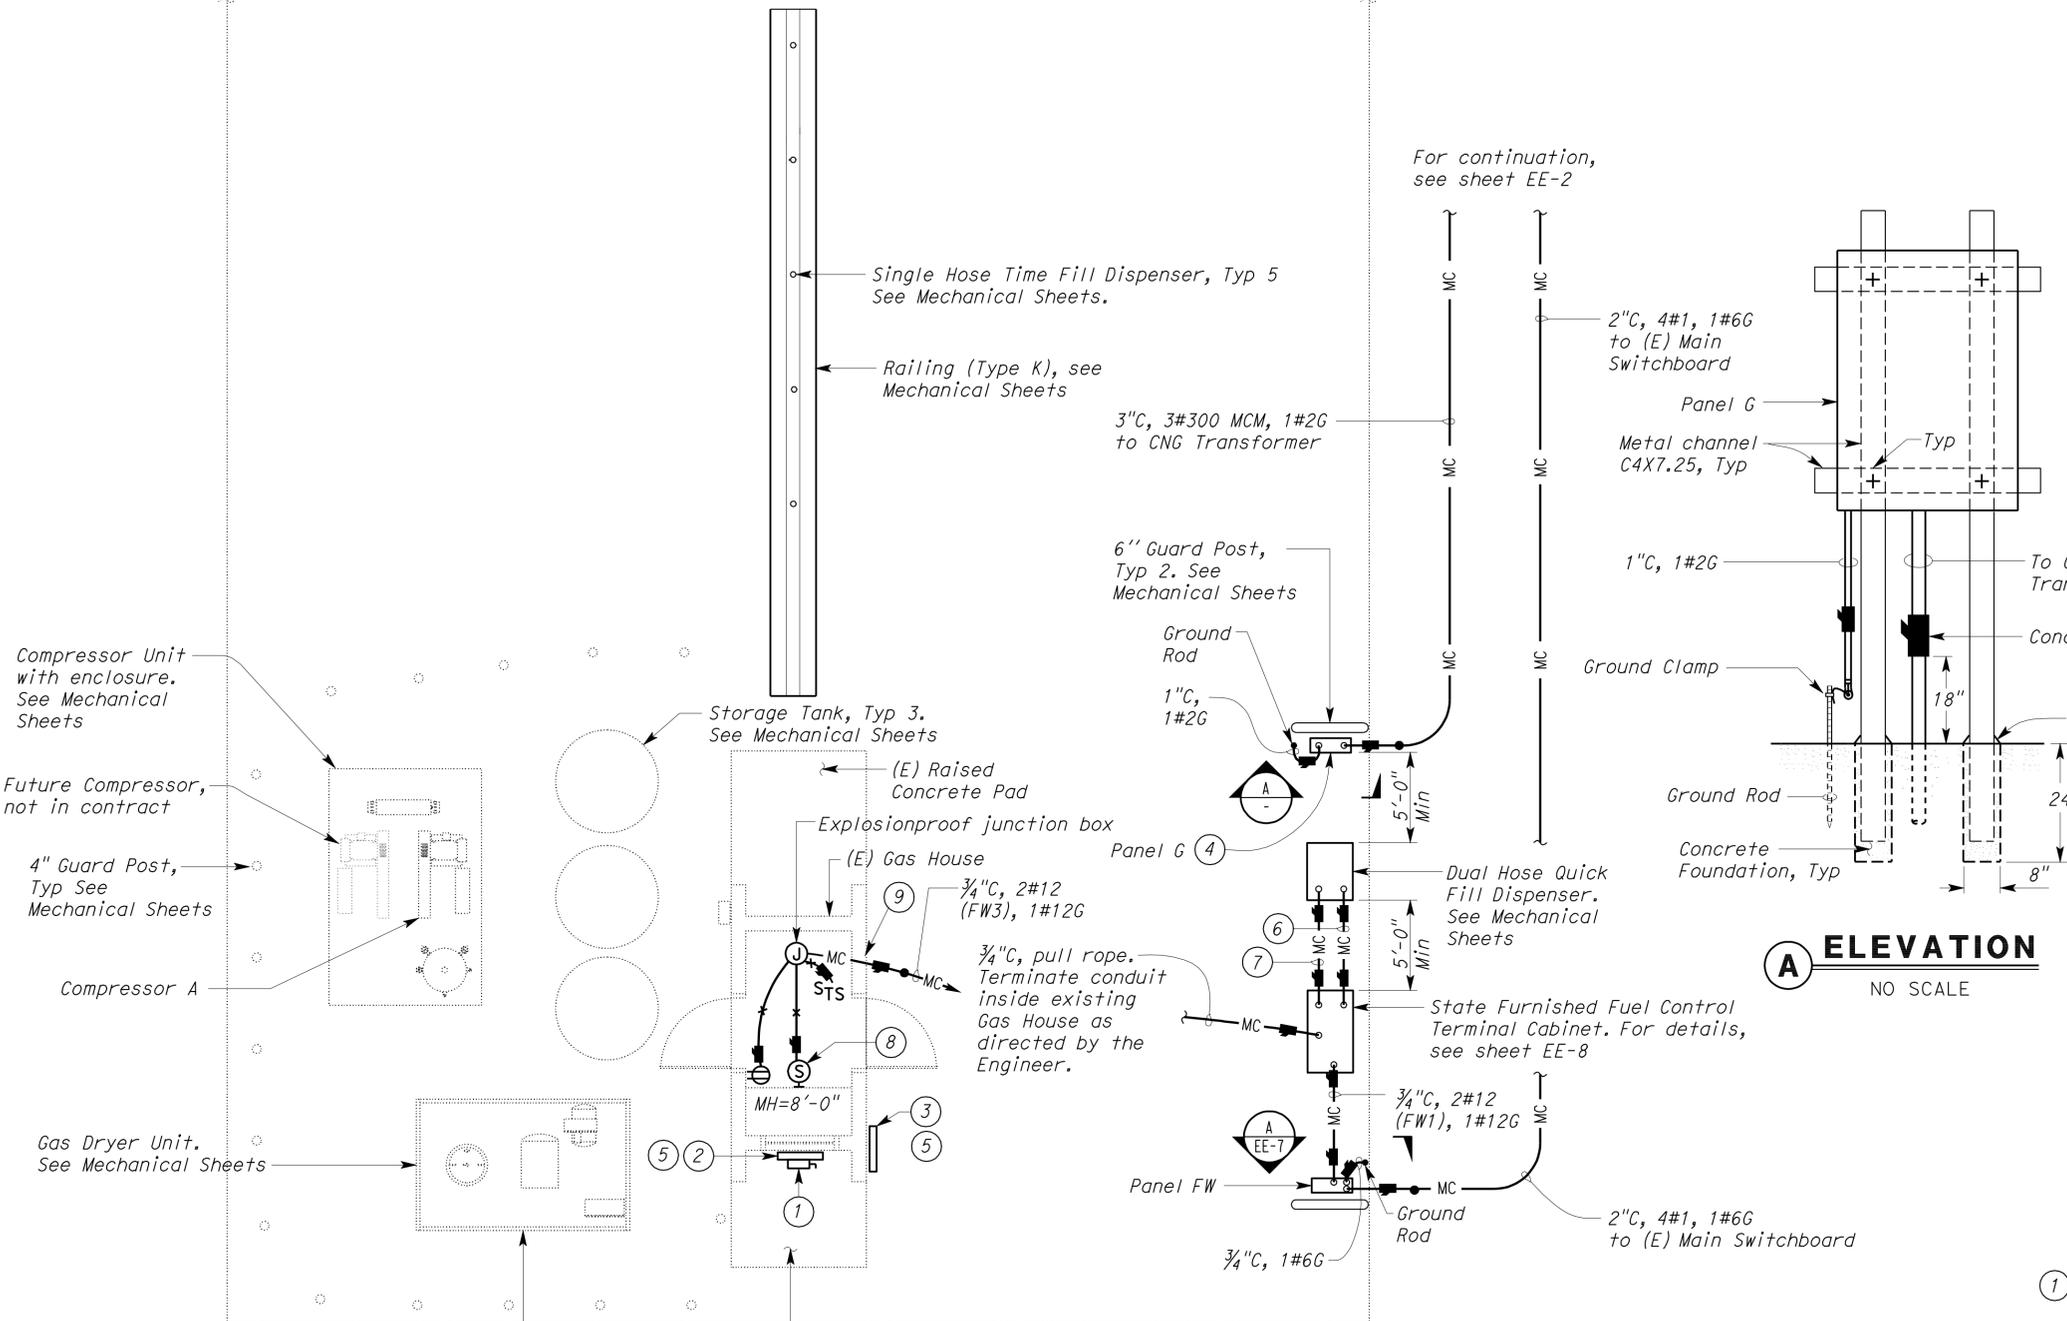- Compressed Natural Gas Fuel System Electrical Requirements:
- All Electrical work required for the CNG Fueling System shall comply with NFPA 52: Vehicular Fuel Systems Code, California Electrical Code 2010, and NFPA 70E: Standard for Electrical Safety in the Workplace.
 - CNG Fueling System shall include all equipment and devices as described under the Mechanical portion of the Special Provisions, and as shown on the Mechanical and Electrical plans.
 - All conduits installed on the west side of the existing Gas House shall be installed on the surface of the existing pavement. Conduit shall be supported to the pavement using unistrut.
 - All conduits installed on the east side of the existing Gas House shall be installed underground.
 - All branch circuit conductors and equipment grounding conductors shall be sized to meet or exceed the following:
 - Voltage drop of any branch circuit conductor shall not exceed 2%.
 - Upon occurrence of any kind of fault at any point in the system, overcurrent protective devices shall trip within 1/2 cycle.
 - For electrical rating of all equipment installed for the entire CNG Fueling System, see Mechanical sheets.

Notes:

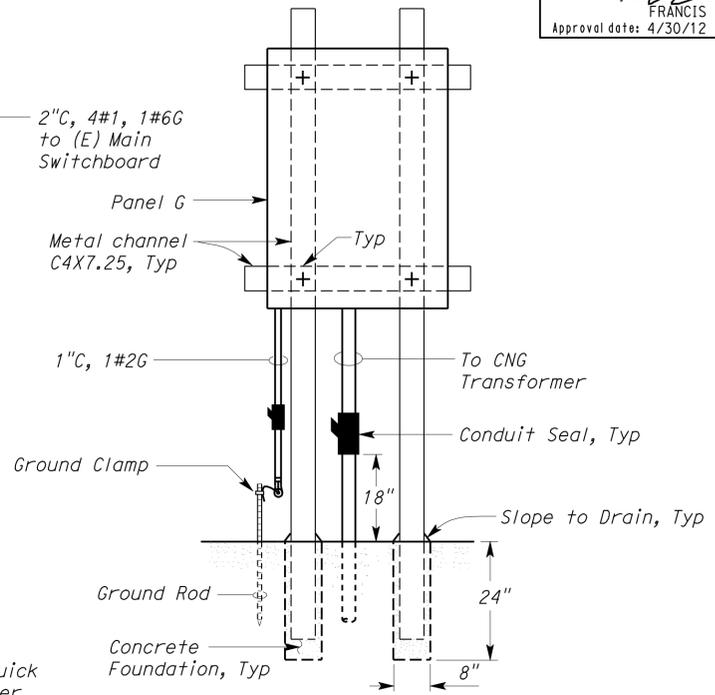- Emergency CNG Shutoff Switch. CNG Shutoff switch shall be included as part of the Compressed Natural Gas design and installation submittal.
- Emergency CNG Shutoff Warning Switch sign (mount above switch). Inscription shall read: EMERGENCY CNG SHUTOFF SWITCH.
- Emergency CNG Shutoff Warning Switch sign. Inscription shall read:
 EMERGENCY CNG SHUTOFF SWITCH
- Size Branch Circuit Breakers as required for overcurrent protection of all Compressed Natural Gas System electrical equipment.
- Fasten warning sign to the wall with at least 6 anchorage devices.

THIS DRAWING ACCURATE FOR ELECTRICAL WORK ONLY


DESIGN BY Joseph Abdelsayed CHECKED J.S. Sandhu DETAILS BY Joseph Abdelsayed CHECKED J.S. Sandhu QUANTITIES BY Joseph Abdelsayed CHECKED J.S. Sandhu	STATE OF CALIFORNIA DEPARTMENT OF TRANSPORTATION	DIVISION OF ENGINEERING SERVICES ELECTRICAL-MECHANICAL-WATER AND WASTEWATER DESIGN	BRIDGE No. POST MILE	MAGANA-ORTEGA MS ENLARGED CNG STATION POWER PLAN	SHEET EE-6	
	ORIGINAL SCALE IN INCHES FOR REDUCED PLANS 0 1 2 3	UNIT PROJECT NUMBER & PHASE 3596 08000004541	DISREGARD PRINTS BEARING EARLIER REVISION DATES REVISION DATES (PRELIMINARY STAGE ONLY) 12/15/10 05/07/12 6/4/12 12/4/12	SHEET OF	DOES SD Imperial Rev. 9/02	16-JAN-2013 05:37 ee_06.dgn

Dist.	COUNTY	LOCATION CODE	POST MILES TOTAL PROJECT	SHEET No.	TOTAL SHEETS
08	SBd	5712		21	22

Joe Abdelsayed
 REGISTERED ELECTRICAL ENGINEER DATE 06-04-12

12-24-12
 PLANS APPROVAL DATE

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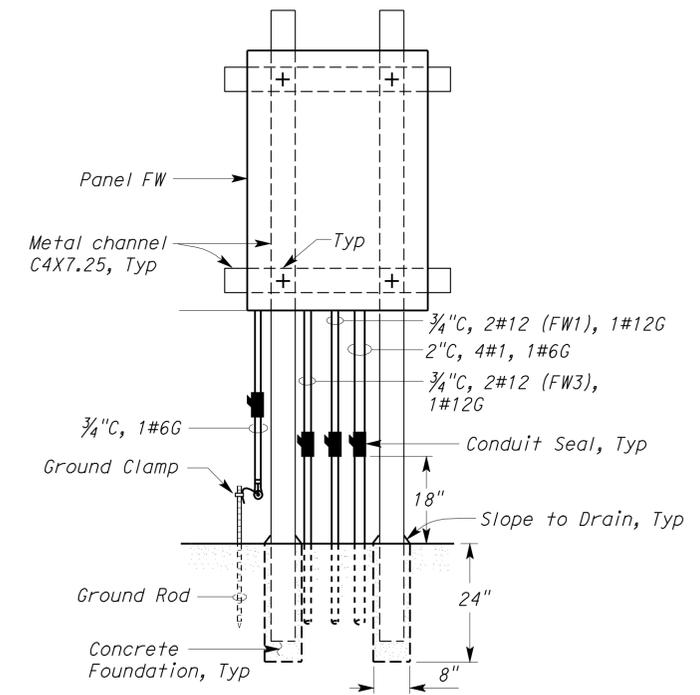
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 Reviewed by: *Francis Solich*
 FRANCIS SOLICH
 Approval date: 4/30/12

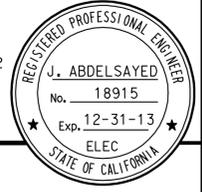MAIN: 100 A/3P
 VOLTS: 120/208, 3-PHASE, 4-WIRE
 FEEDER SIZE: 4#1, 1#6G
 LOCATION: CNG STATION

PANEL FW

DESCRIPTION	AMPERES			BRK	CKT	A	B	C	CKT	BRK	AMPERES			DESCRIPTION
	A	B	C								A	B	C	
FUEL CONTROL TERMINAL	10			20/1	1	•			2			-		
GAS HOUSE RECEPTACLE AND LIGHT		3		20/1	3		•		4	30/3		-		SPARE
SPARE			-	20/1	5			•	6			-		
SPARE	-			20/1	7			•	8			-		
SPARE		-		20/1	9			•	10	30/3		-		SPARE
SPARE			-	20/1	11			•	12			-		
SPACE	-				13			•	14			-		SPACE
SPACE		-			15			•	16			-		SPACE
SPACE			-		17			•	18			-		SPACE
SPACE	-				19			•	20			-		SPACE
SPACE		-			21			•	22			-		SPACE
SPACE			-		23			•	24			-		SPACE
SPACE	-				25			•	26			-		SPACE
SPACE		-			27			•	28			-		SPACE
SPACE			-		29			•	30			-		SPACE

A	B	C	TOTAL CONNECTED LOAD (AMPERES PER PHASE)
10	3	-	



A ELEVATION
 NO SCALE


THIS DRAWING ACCURATE FOR ELECTRICAL WORK ONLY

DESIGN BY <i>Joseph Abdelsayed</i> CHECKED <i>J.S. Sandhu</i> DETAILS BY <i>Joseph Abdelsayed</i> CHECKED <i>J.S. Sandhu</i> QUANTITIES BY <i>Joseph Abdelsayed</i> CHECKED <i>J.S. Sandhu</i>	STATE OF CALIFORNIA DEPARTMENT OF TRANSPORTATION	DIVISION OF ENGINEERING SERVICES ELECTRICAL-MECHANICAL-WATER AND WASTEWATER DESIGN	BRIDGE No.	MAGANA-ORTEGA MS PANEL FW DETAILS	SHEET	
			POST MILE		12/15/10 05/07/12 6/4/12 12/4/12	OF
			PROJECT NUMBER & PHASE 08000004541			DISREGARD PRINTS BEARING EARLIER REVISION DATES

ORIGINAL SCALE IN INCHES FOR REDUCED PLANS 0 1 2 3
 UNIT PROJECT NUMBER & PHASE 3596 08000004541
 DOES SD Imperial Rev. 9/02
 EA 08-0M0204

Dist.	COUNTY	LOCATION CODE	POST MILES TOTAL PROJECT	SHEET No.	TOTAL SHEETS
08	SBd	5712		22	22



 REGISTERED ELECTRICAL ENGINEER DATE 06-04-12
 12-24-12
 PLANS APPROVAL DATE

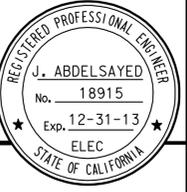

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ACCESSIBILITY DESIGN APPROVAL STAMP
 DOT / DES / OTA
 PROJECT ID
0800000454
 Reviewed by: 
 YA WANG
 Date: 4/27/12

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 Reviewed by: 
 FRANCIS SOLICH
 Approval date: 4/30/12

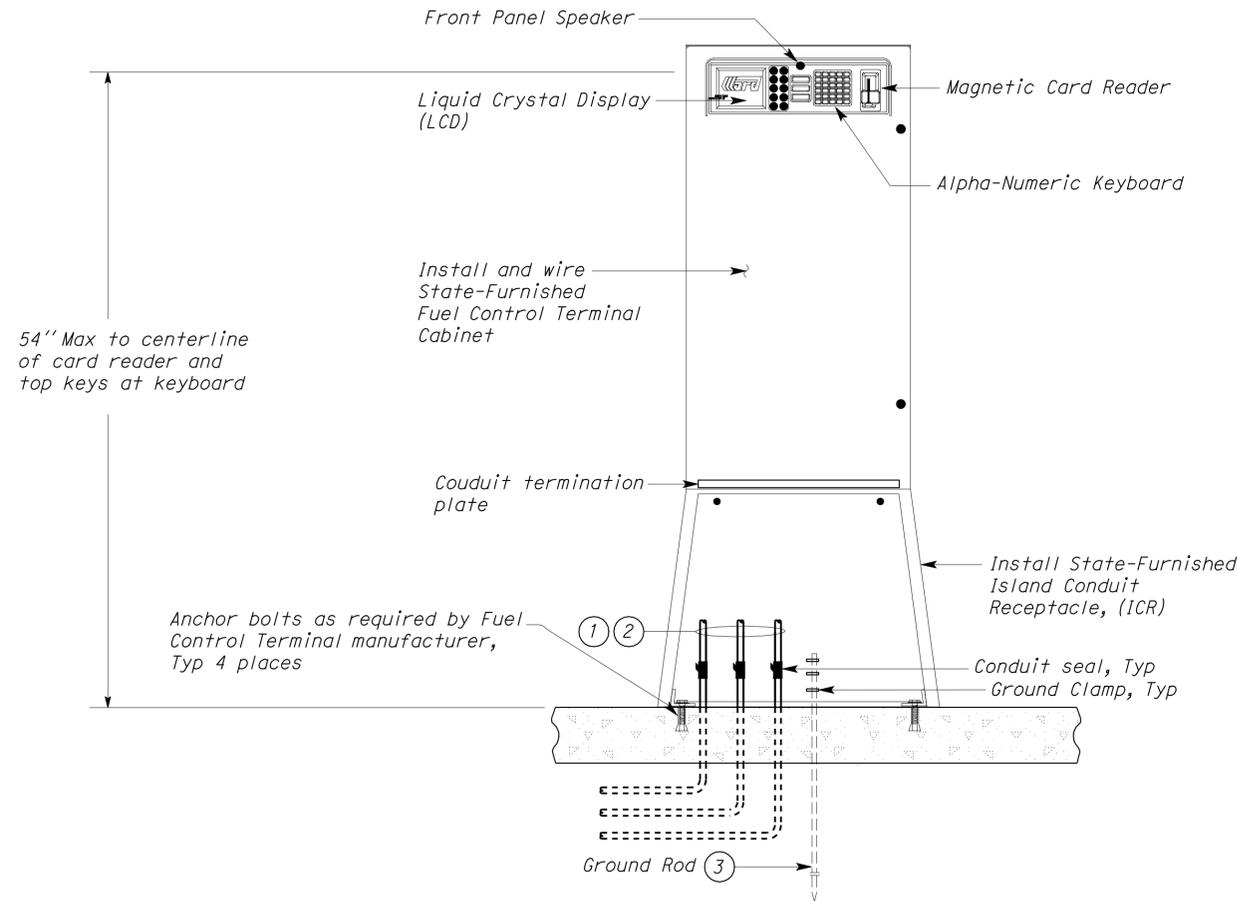

General Note:

- A. Not all electrical components and interconnections are shown. Perform all work as required for the complete installation of the Fuel Control Terminal.

Notes:

- ① For number and size of conduits and conductors to and from ICR, see sheet EE-6.
- ② Install conduit seal in conduit run and extend conduit to allow for termination on conduit termination plate on top of the ICR.
- ③ Conduit connections from ground rod to metal piping of Gasoline and Diesel Fuel and Panel G are not shown for clarity.

A FUEL CONTROL TERMINAL DETAIL
NO SCALE

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DESIGN	BY	Joseph Abdelsayed	CHECKED	J.S. Sandhu	STATE OF CALIFORNIA DEPARTMENT OF TRANSPORTATION	DIVISION OF ENGINEERING SERVICES ELECTRICAL-MECHANICAL-WATER AND WASTEWATER DESIGN	BRIDGE No.	MAGANA-ORTEGA MS	SHEET EE-8	
	DETAILS	BY	Joseph Abdelsayed	CHECKED			J.S. Sandhu			POST MILE
	QUANTITIES	BY	Joseph Abdelsayed	CHECKED			J.S. Sandhu			DETAILS
ORIGINAL SCALE IN INCHES FOR REDUCED PLANS					0 1 2 3	UNIT PROJECT NUMBER & PHASE	3596 08000004541	DISREGARD PRINTS BEARING EARLIER REVISION DATES	REVISION DATES (PRELIMINARY STAGE ONLY)	SHEET OF
DOES SD Imperial Rev. 9/02								12/15/10 05/02/12 6/4/12 12/4/12		